

PROPOSED SITE DEVELOPMENT CEC SOLAR #1056 LLC

SITE DRAWINGS

ISSUED FOR: PERMITTING
DATE ISSUED: AUGUST 12, 2015
LATEST ISSUE: OCTOBER 3, 2016

WORCESTER DISTRICT REGISTER
OF DEEDS-WORCESTER, MA
PLAN BOOK 923 PLAN 10
Received 10/21/16
Sheet 1 of 14
With Doc. #
In BOOK PAGE
Fee \$ 4,050
ATTEST: [Signature]
FOR REGISTRY USE ONLY

207 PROVIDENCE ROAD
GRAFTON, MASSACHUSETTS



SCALE: 1"=600'

INDEX TO DRAWINGS

SHEET NO.	DRAWING TITLE
N-1	TITLE SHEET
EC-1	NOTES & LEGEND
SL-1	EXISTING CONDITIONS
SGD-1	SITE LAYOUT
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EROS-1	ACCESS ROAD PLAN & PROFILES
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DEC-1	SITE DETAILS
	SPECIAL PERMIT/SITE PLAN APPROVAL DECISIONS

I HEREBY CERTIFY THAT THE PROPERTY LINES SHOWN ON THIS PLAN ARE THE LINES DIVIDING EXISTING OWNERSHIPS, AND THE LINES OF THE STREETS AND WAYS SHOWN ARE THOSE OF PUBLIC OR PRIVATE STREETS OR WAYS ALREADY ESTABLISHED, AND THAT NO NEW LINES FOR DIVISION OF EXISTING OWNERSHIP OR FOR NEW WAYS ARE SHOWN. (MASS GENERAL LAWS CHAPTER 41, SECTION 81-X)

THE ABOVE CERTIFICATION IS INTENDED TO MEET REGISTRY OF DEEDS REQUIREMENTS AND IS NOT A CERTIFICATION TO THE TITLE OR OWNERSHIP OF THE PROPERTY SHOWN. OWNERS OF THE PROPERTIES SHOWN ARE ACCORDING TO THE CURRENT TOWN ASSESSOR'S RECORDS.

I FURTHER CERTIFY THAT THIS PLAN CONFORMS TO THE RULES AND REGULATIONS OF THE REGISTERS OF DEEDS OF THE COMMONWEALTH OF MASSACHUSETTS.

[Signature] 10-19-16
PROFESSIONAL LAND SURVEYOR DATE




SCALE: 1"=1000'

--- 300' NOTIFICATION LINE
--- PROJECT SITE

THIS IS TO CERTIFY THAT THIS PLAN WAS DESIGNED TO COMPLY WITH THE PERFORMANCE STANDARDS SET FORTH SECTION 4.1 OF THE TOWN OF GRAFTON ZONING BY-LAWS.

[Signature]
REGISTERED PROFESSIONAL ENGINEER

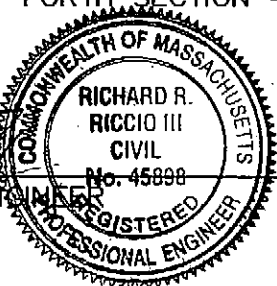


10/19/16
DATE

LOT NO.	OWNER OF RECORD
99/1	JOHN H. MAGILL
99/4	HILLVIEW ESTATE INC. TRUSTEE
99/9	PROVIDENCE ROAD COMMONS, LLC
99/10A	JOHN D. KIMBERLY KELL
99/10C	SANDRA JEAN SHIELDS
100/300	MAGILL ASSOCIATES
107/12	NEW ENGLAND POWER COMPANY
107/13	NEW ENGLAND POWER COMPANY
107/14	LAURA A. & PRIMO BORELLI III
107/15	WALTER LUSSIER
107/16	ROBERT HUHOWSKI & STEPHEN A. HUCHOWSKI
107/17	ROBERT HUHOWSKI & STEPHEN A. HUCHOWSKI
107/18	JOHN A. GENDRON & JOYCE A. GIBREE
107/19	MARTIN D. SZERLAG JR. & FRANK J. SZERLAG
107/101	BROADMEADOW REALTY LLC
108/1	SUSAN TOMKIEWICZ ET ALS TRUSTEES

PROPOSED SITE DEVELOPMENT

MAP 99, LOT 10

207 PROVIDENCE ROAD
GRAFTON, MA

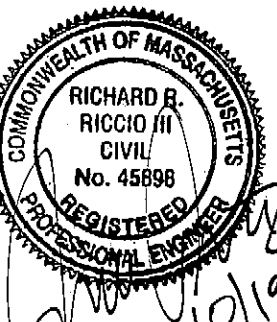

FIELD ENGINEERING CO., INC. CONSULTING ENGINEERS

110 INDUSTRIAL DRIVE
P.O. BOX 1178
MATTAPAN, MA 02739
TEL: (508) 758-2749
FAX: (508) 758-2849

THE CROCKER BUILDING
4 COURT STREET SUITE 104
TAUNTON, MA 02780
TEL: (508) 824-9279
FAX: (508) 824-9276

Project No. 2035
Sheet 1 OF 14

ENGINEER:

FIELD ENGINEERING CO., INC.
11D INDUSTRIAL DRIVE
P.O. BOX 1178
MATTAPAN, MASSACHUSETTS 02739

APPLICANT:

CEC SOLAR #1056 LLC
C/O CLEAN ENERGY COLLECTIVE, LLC
146 W. BOYLSTON DRIVE
WORCESTER, MASSACHUSETTS 01606

PROPERTY OWNERS:

ROBERT & KAREN KELL
207 PROVIDENCE ROAD
GRAFTON, MASSACHUSETTS 01519-1506

PROJECT LOCATION:

207 PROVIDENCE ROAD
ASSESSORS MAP 99, LOT 10
GRAFTON, MASSACHUSETTS

GENERAL CONSTRUCTION NOTES

1. THE MATERIALS AND CONSTRUCTION OF ALL THE PROPOSED STORM DRAINAGE UTILITIES SHALL CONFORM TO THE SPECIFICATIONS SHOWN HEREIN AS WELL AS ALL APPLICABLE MASSDOT STANDARDS AND SPECIFICATIONS, LATEST EDITION. THE MATERIALS AND CONSTRUCTION OF ALL ELECTRIC, TELEPHONE & CATV UTILITIES SHALL CONFORM TO THE SPECIFICATIONS OF EACH RESPECTIVE PUBLIC UTILITY PROVIDER.
2. ALL CONSTRUCTION MATERIALS, AS WELL AS ALL MATERIAL SHOP DRAWINGS AND MANUFACTURERS DATA SHALL RECEIVE THE WRITTEN APPROVAL OF THE THE PROJECT ENGINEER PRIOR TO FABRICATION AND INSTALLATION.
3. THE LOCATION AND ELEVATION OF ALL EXISTING UTILITIES SHALL BE CONSIDERED APPROXIMATE AND MUST BE VERIFIED BY THE CONTRACTOR PRIOR TO ANY CONSTRUCTION. UNDERGROUND UTILITIES SHOWN ARE FROM FIELD OBSERVATION AND THE BEST AVAILABLE RECORD INFORMATION AND ARE NOT WARRANTED TO BE EXACT, NOR IS IT WARRANTED THAT ALL UNDERGROUND PIPES OR STRUCTURES ARE SHOWN. THE CONTRACTOR SHALL CONTACT THE RESPECTIVE UTILITY COMPANIES RELATIVE TO THE LOCATION AND ELEVATION OF ALL EXISTING LINES.
4. THE CONTRACTOR SHALL CONTACT "DIG SAFE" AT 1-800-322-4844, 72 HOURS PRIOR TO ANY EXCAVATION AND/OR SUBSURFACE TESTING TO INFORM THE UTILITY COMPANIES OF ANY EXCAVATION.
5. WHENEVER EXISTING STRUCTURES ARE ENCOUNTERED, THE CONTRACTOR SHALL REPAIR ANY DAMAGED STRUCTURES OR REPLACE ANY REMOVED STRUCTURES, AND MAKE ANY IMPROVEMENTS ABOVE OR BELOW GRADE TO A CONDITION BETTER THAN OR EQUAL TO PRE-EXISTING CONDITIONS.
6. ALL EXCAVATED MATERIAL DESIGNATED FOR REUSE SHALL BE STOCKPILED ON SITE NO HIGHER THAN 8 FEET AND SHALL BE ENCLOSED BY TEMPORARY SILT FENCES TO PREVENT TRAVEL OF SEDIMENT TO ADJACENT PROPERTIES OR DRAINAGE WAYS.
7. THE CONTRACTOR SHALL BE RESPONSIBLE FOR THE DISPOSAL OF ALL WASTE MATERIAL AT AN APPROVED LOCATION. BURIAL OF WASTE MATERIAL ON SITE WILL NOT PERMITTED.
8. EROSION CONTROL MEASURES SHALL REMAIN IN PLACE AND MAINTAINED IN GOOD CONDITION UNTIL SURFACE RESTORATION IS COMPLETE AND ALL AREAS DISTURBED BY THE CONTRACTORS OPERATIONS ARE STABILIZED.
9. THE CONTRACTOR SHALL PROTECT ADJACENT PROPERTIES FROM ON SITE CONSTRUCTION ACTIVITIES AND REMOVE ANY SEDIMENT OR DEBRIS DEPOSITED THEREON IMMEDIATELY.
10. DRAINAGE GENERATED AS A RESULT OF TRENCH DEWATERING SHALL BE DISCHARGED TO EXISTING DRAINAGE COURSES WITH PROPER EROSION CONTROL, AND DEWATERING MEASURES MEASURES SUBJECT TO APPROVAL BY THE PROJECT ENGINEER. DIRECT DISCHARGE ONTO PAVEMENT, WETLANDS OR PRIVATE PROPERTY SHALL NOT BE ALLOWED WITHOUT CONSENT OF THE PROJECT ENGINEER AND THE OWNER.
11. THE OWNER AND THE PROJECT ENGINEER SHALL APPROVE ALL FIELD CHANGES IN THE WORK PRIOR TO IMPLEMENTATION. NO FIELD CHANGES SHALL BE MADE IN ANY SPECIFIED SITE WORK OR ANY MATERIALS FOR WHICH SHOP DRAWINGS HAVE BEEN SUBMITTED AND APPROVED WITHOUT PRIOR CONSULTATION OF THE OWNER AND THE PROJECT ENGINEER. ANY CHANGES SO MADE WITHOUT THE CONSENT OF THE OWNER AND THE PROJECT ENGINEER SHALL, IF DEEMED UNACCEPTABLE BY EITHER PARTY, BE PROMPTLY REMOVED FROM THE WORK AT NO EXPENSE TO THE OWNER OF THE PROJECT.
12. ANY WORK OR MATERIALS NOT MEETING THE APPROVED STANDARDS AND SPECIFICATIONS OF THE LOCAL DEPT. OF PUBLIC WORKS SHALL BE IMMEDIATELY REMOVED AND REPLACED AT THE FULL RESPONSIBILITY AND COST/EXPENSE TO THE CONTRACTOR.
13. THE CONTRACTOR SHALL BE RESPONSIBLE FOR ALL SITE PREPARATION, THE COORDINATION AND INSTALLATION OF ALL UTILITY CONNECTIONS, AND RELATED WORK INCLUDING BUT NOT LIMITED TO ALL NECESSARY SHORING, BRACING AND TRENCH DEWATERING FOR THE COMPLETE INSTALLATION OF THE PROJECT FACILITIES DURING CONSTRUCTION.
14. ALL OPEN EXCAVATIONS SHALL BE ADEQUATELY SAFEGUARDED IN STRICT ACCORDANCE WITH OSHA GUIDELINES AND TO THE SATISFACTION OF THE LOCAL POLICE DEPARTMENT. PROVISIONS FOR TEMPORARY BARRICADES, CAUTION SIGNS, LIGHTS AND OTHER MEANS TO PREVENT ACCIDENTS AND DAMAGE TO PROPERTY ARE THE RESPONSIBILITY OF THE CONTRACTOR. THE CONTRACTOR SHALL PROVIDE SUITABLE AND SAFE BRIDGES AND OTHER CROSSINGS FOR ACCOMMODATING TRAVEL BY PEDESTRIANS AND WORKMEN. NO EXCAVATIONS SHALL REMAIN OPEN OVERNIGHT.
15. REFER TO CONSTRUCTION DETAILS ON THIS SHEET FOR ADDITIONAL UTILITY REQUIREMENTS AND SPECIFICATIONS.
16. THESE PLANS HAVE BEEN PREPARED SPECIFICALLY AS SUPPLEMENTAL INFORMATION TO ACCOMPANY APPLICABLE PERMIT APPLICATIONS AND ARE NOT INTENDED FOR ACTUAL CONSTRUCTION WITHOUT THE EXPRESSED WRITTEN APPROVAL OF FIELD ENGINEERING CO., INC.
17. ALL SLOPES SHALL BE GRADED AT NO LESS THAN 3:1 UNLESS OTHERWISE SHOWN ON THE PLANS. LAND DISTURBING ACTIVITIES WITHIN ANY LANDSCAPE BUFFER LINES SHALL BE KEPT TO A MINIMUM. NO STOCKPILING OF RESIDUALS WILL BE ALLOWED WITHIN ANY LANDSCAPE BUFFER ZONE AREAS OR DESIGNATED NO DISTURBANCE AREAS.

EROSION & SEDIMENTATION CONTROL PROGRAM

1. ALL SEDIMENT AND EROSION CONTROL MEASURES SHALL BE EXECUTED IN ACCORDANCE WITH THE FOLLOWING REQUIREMENTS AND THE NPDES STORMWATER POLLUTION PREVENTION PLAN (SWPPP).
2. THOSE AREAS UNDERGOING ACTUAL CONSTRUCTION WILL BE LEFT IN AN UNTREATED OR UNVEGETATED CONDITION FOR A MINIMUM TIME. AREAS SHALL BE PERMANENTLY STABILIZED WITHIN 15 DAYS OF FINAL GRADING AND TEMPORARILY STABILIZED WITHIN 30 DAYS OF INITIAL DISTURBANCE OF THE SOIL IF THE DISTURBANCE IS WITHIN 100 FEET OF A WETLAND RESOURCE AREA. THE DISTURBED AREAS SHALL BE STABILIZED WITHIN 7 DAYS OR PRIOR TO ANY FORECASTED STORM EVENT.
3. SEDIMENT BARRIERS (SILT FENCE, HAY BARRIERS, ETC.) SHOULD BE INSTALLED PRIOR TO ANY SOIL DISTURBANCE OF THE UPSTREAM CONTRIBUTING DRAINAGE AREA. MULCH NETTING SHALL BE USED TO ANCHOR MULCH IN ALL AREAS WITH SLOPES GREATER THAN 8.0% AFTER OCTOBER 1ST.
4. INSTALL SILT FENCE AT TOE OF SLOPE TO FILTER SILT FROM RUNOFF. SEE SILT FENCE DETAIL FOR PROPER INSTALLATION. SILT FENCE WILL REMAIN IN PLACE PER NOTE #5.
5. ALL EROSION CONTROL STRUCTURES WILL BE INSPECTED, REPLACED AND/OR REPAIRED EVERY 7 DAYS AND IMMEDIATELY FOLLOWING ANY SIGNIFICANT RAINFALL, SNOW MELT OR WHEN NO LONGER SERVICEABLE DUE TO SEDIMENT ACCUMULATION OR DECOMPOSITION. SEDIMENT DEPOSITS SHOULD BE REMOVED AFTER EACH STORM EVENT AND WHEN THE DEPOSITS REACH APPROXIMATELY ONE HALF THE HEIGHT OF THE BARRIER. SEDIMENT CONTROL DEVICES SHALL REMAIN IN PLACE AND BE MAINTAINED BY THE CONTRACTOR UNTIL AREAS UPSLOPE ARE STABILIZED BY TURF.
6. NO SLOPES, EITHER PERMANENT OR TEMPORARY, SHALL BE STEEPER THAN TWO TO ONE (2 TO 1) UNLESS NOTED OTHERWISE.
7. IF FINAL SEEDING OF THE DISTURBED AREAS IS NOT COMPLETED 45 DAYS PRIOR TO THE FIRST KILLING FROST, USE TEMPORARY MULCH OR DORMANT SEEDING TO PROTECT THE SITE AND DELAY SEEDING UNTIL THE NEXT RECOMMENDED SEEDING PERIOD.
8. TEMPORARY SEEDING OF DISTURBED AREAS THAT HAVE NOT BEEN FINAL GRADED SHALL BE COMPLETED 45 DAYS PRIOR TO THE FIRST KILLING FROST TO PROTECT FROM SPRING RUNOFF PROBLEMS.
9. REVEGETATION MEASURES WILL COMMENCE UPON COMPLETION OF CONSTRUCTION EXCEPT AS NOTED ABOVE. ALL DISTURBED AREAS NOT OTHERWISE STABILIZED WILL BE GRADED, SMOOTHED, AND PREPARED FOR FINAL SEEDING AS FOLLOWS:
 - A) ANY TOPSOIL TO BE PLACED FOR REVEGETATION MEASURES (WHETHER SCREENED ON-SITE OR IMPORTED) SHALL HAVE A SANDY LOAM TEXTURE RELATIVELY FREE OF SUBSOIL MATERIAL, STONES, ROOTS, LUMPS OF SOIL, TREE LIMBS, TRASH OR CONSTRUCTION DEBRIS, AND SHALL BE PLACED TO A DEPTH OF FOUR (4) INCHES ON ALL LOAM AND SEED AREAS OR AS SPECIFIED ON THE DRAWINGS.
 - B) APPLY FERTILIZER AND/OR LIMESTONE (EQUIVALENT TO 50% CALCIUM PLUS MAGNESIUM OXIDE) AT MANUFACTURER'S RECOMMENDED RATES.
 - C) THE DESIGN MIXES FOR SEEDING SHALL BE IN ACCORDANCE WITH THE FOLLOWING TABLES. THE SEED MIX SHALL BE INOCULATED WITHIN TWENTY-FOUR (24) HOURS, BEFORE MIXING AND PLANTING, WITH APPROPRIATE INOCULUM FOR EACH VARIETY. (ALTERNATIVE SEED MIXES SHALL BE APPROVED BY THE ENGINEER AND CONSERVATION COMMISSION PRIOR TO CONSTRUCTION)

LOAM AND SEED AREAS -- UNDER SOLAR ARRAY

TYPE	% BY WEIGHT
YELLOW BLOSSOM SWEETCLOVER	25
ALSKIE CLOVER	25
CRIMSON CLOVER	15
MEDIUM RED CLOVER	20
DUTCH WHITE CLOVER	15

LOAM AND SEED AREAS -- OUTSIDE SOLAR ARRAY AREAS--WILDFLOWER SEED MIX

TYPE	% BY WEIGHT
PASTURE PEAS	15
DOTTED MINT	10
WILD BERGAMOT	10
VIRGINIA MOUNTAIN MINT	10
BLUE VERVAIN	20
BLAZING STAR	2
SMOOTH BLUE ASTER	10
CALICO ASTER	12
ANISE HYSSOP	4
MISCELLANEOUS WILDFLOWERS	4

APPLICATION RATE 10 LBS./1 ACRE

10. HAY OR STRAW MULCH SHALL BE LOOSELY SPREAD TO A UNIFORM DEPTH AT THE RATE OF 4.5 TONS PER ACRE EXCEPT OVER CERTAIN SELECTED SEEDED AREAS WHERE 2 TONS PER ACRE SHALL BE USED AS DIRECTED BY THE ENGINEER AND/OR THE PLANNING BOARD. A HYDRO-APPLICATION OF WOOD OR PAPER FIBER SHALL BE APPLIED FOLLOWING SEEDING. A SUITABLE BINDER SUCH AS CURASOL OR RMB PLUS WILL BE USED ON HAY MULCH FOR WIND CONTROL.
11. ALL TEMPORARY EROSION CONTROL MEASURES SHALL BE REMOVED ONCE THE SITE IS STABILIZED TO THE SATISFACTION OF THE PROJECT ENGINEER AND/OR THE CONSERVATION COMMISSION.
12. ADJACENT PROPERTIES WILL BE PROTECTED WITH HAY BALES AND/OR SILT FENCING INSTALLED AS SHOWN ON THE DRAWINGS. ADDITIONAL HAY BALES OR SAND BAGS SHALL BE LOCATED AS CONDITIONS WARRANT OR AS DIRECTED BY THE PROJECT ENGINEER AND/OR THE CONSERVATION COMMISSION.
13. TEMPORARY HAY BALE EROSION CHECKS OR FILTER FABRIC GRATE INSERTS SHALL BE PROVIDED AT ALL DRAINAGE STRUCTURE INLETS DURING CONSTRUCTION. UPON COMPLETION OF CONSTRUCTION AND SATISFACTORY STABILIZATION OF DISTURBED AREAS, THE CONTRACTOR SHALL CLEAN ALL CATCH BASIN SUMPS AND DRAIN INVERTS.
14. THE CONTRACTOR MUST REPAIR OR RESEED ANY AREAS THAT DO NOT DEVELOP WITHIN THE PERIOD OF ONE YEAR AND SHALL DO SO AT NO ADDITIONAL EXPENSE TO THE OWNER.
15. THE NORMAL ACCEPTABLE SEASONAL SEEDING DATES ARE APRIL 1ST THROUGH JUNE 15TH AND AUGUST 15TH THROUGH SEPTEMBER 30TH.
16. STOCKPILES OF TOP SOIL SHALL NOT BE LOCATED NEAR WATERWAYS. THEY SHALL HAVE SIDE SLOPES NO GREATER THAN 1:1.

MULCH AND MULCH ANCHORING

MULCH LOCATION	MULCH	RATE (1,000 S.F.)
MILD SLOPES LESS THAN 3:1	STRAW OR HAY	200 POUNDS
HIGH WIND VELOCITY AREAS	SHREDDED OR CHOPPED CORNSTALKS	200-275 POUNDS
MODERATE TO HIGH VELOCITY AREAS	ANCHORED STRAW OR HAY (1)	200 POUNDS
STEEP SLOPES GREATER THAN 3:1	LUTE MESH OR EXCELSIOR MAT	AS REQUIRED
	JUTE MESH OR EXCELSIOR MAT	AS REQUIRED

(1) A HYDRO-APPLICATION OF WOOD OR PAPER FIBER MAY BE APPLIED FOLLOWING SEEDING. A SUITABLE BINDER SUCH AS CURASOL OR RMB PLUS SHALL BE USED ON HAY MULCH FOR WIND CONTROL.

MULCH ANCHORING

MULCH ANCHORING MAY BE ACCOMPLISHED WITH PEG AND TWINE (1 SQ. YD./BLOCK); MULCH NETTING (PER MANUFACTURERS SPECIFICATIONS); WOOD CELLULOSE FIBER (750 LBS/ACRE); OR CHEMICAL TACK (PER MANUFACTURERS SPECIFICATIONS).

EROSION CONTROL NOTES DURING CONSTRUCTION

1. CONSTRUCTION ACTIVITY EXECUTED DURING THE WINTER CONSTRUCTION PERIOD BETWEEN NOVEMBER 1 THROUGH APRIL 15 SHALL BE SUBJECT TO THE FOLLOWING ADDITIONAL REQUIREMENTS.
2. EXPOSED AREA SHOULD BE LIMITED TO THAT WHICH CAN BE MULCHED OR TEMPORARY STABILIZED IN ONE DAY PRIOR TO ANY SNOW EVENT.
3. CONTINUATION OF EARTHWORK OPERATIONS ON ADDITIONAL AREAS SHALL NOT BEGIN UNTIL THE EXPOSED SOIL SURFACE ON THE AREA BEING WORKED HAS BEEN STABILIZED SUCH THAT NO AREA IN EXCESS OF ONE ACRE IS WITHOUT EROSION CONTROL PROTECTION.
4. AN AREA SHALL BE CONSIDERED TO HAVE BEEN STABILIZED WHEN EXPOSED SURFACES HAVE BEEN EITHER MULCHED WITH STRAW OR HAY AND ADEQUATELY ANCHORED BY AN APPROVED ANCHORING TECHNIQUE.
5. BETWEEN THE DATES OF OCTOBER 15 AND APRIL 1ST, LOAM OR SEED WILL NOT BE PERMITTED. DURING PERIODS OF ABOVE FREEZING TEMPERATURES, THE SLOPES SHALL BE FINE GRADED AND EITHER PROTECTED WITH MULCH OR TEMPORARILY SEEDED AND MULCHED UNTIL SUCH TIME AS THE FINAL TREATMENT CAN BE APPLIED.

IF THE DATE IS AFTER NOVEMBER 1ST AND IF THE EXPOSED AREA HAS BEEN LOAMED, FINAL GRADED AND IS SMOOTH, THEN THE AREA MAY BE DORMANT SEED AT A RATE OF 200 TO 300# HIGHER THAN SPECIFIED FOR PERMANENT SEED AND THEN MULCHED. IF CONSTRUCTION CONTINUES DURING FREEZING WEATHER, ALL EXPOSED AREAS SHALL BE CONTINUOUSLY GRADED BEFORE FREEZING AND THE SURFACE TEMPORARILY PROTECTED FROM EROSION BY THE APPLICATION OF MULCH. SLOPES SHALL NOT BE LEFT UNEXPOSED OVER THE WINTER OR ANY OTHER EXTENDED TIME OF WORK SUSPENSION UNLESS TREATED IN THE ABOVE MANNER.
- UNTIL SUCH TIME AS WEATHER CONDITIONS ALLOW DITCHES TO BE FINISHED WITH THE PERMANENT SURFACE TREATMENT, EROSION SHALL BE CONTROLLED BY THE INSTALLATION OF HAY BALE/SAND BAG CHECK DAMS.
6. BETWEEN THE DATES OF NOVEMBER 1ST AND APRIL 15TH ALL MULCH SHALL BE ANCHORED BY EITHER PEG LINE, MULCH NETTING, ASPHALT EMULSION CHEMICAL, TRACK OR WOOD CELLULOSE FIBER.

MULCH NETTING SHALL BE USED TO ANCHOR MULCH IN ALL DRAINAGE WAYS WITH A SLOPE GREATER THAN 3% , FOR SLOPES EXPOSED TO DIRECT WINDS, AND FOR ALL OTHER SLOPES GREATER THAN 8%.

MULCH NETTING SHALL BE USED TO ANCHOR MULCH IN ALL AREAS WITH SLOPES GREATER THAN 15% AFTER OCTOBER 1ST THE SAME APPLIES FOR ALL SLOPES GREATER THAN 8%.
7. ALL EROSION MITIGATION SHALL BE IN PLACE PRIOR TO ANY SOIL DISTURBANCE ACTIVITIES ON THE SITE.

STORMWATER FACILITY OPERATION/MAINTENANCE PLAN

PROPERTY OWNER:

ROBERT & KAREN KELL
207 PROVIDENCE ROAD
GRAFTON, MASSACHUSETTS 01519-1506

APPLICANT/PROPOSER:

CEC SOLAR #1056 LLC
146 W. BOYLSTON DRIVE
WORCESTER, MASSACHUSETTS 01606

1. THE CONTRACTOR SHALL BE RESPONSIBLE FOR THE PROPER INSPECTION AND MAINTENANCE OF ALL STORMWATER MANAGEMENT FACILITIES INCLUDING THE CONTINUED STABILIZATION OF THE SITE UNTIL SUCH TIME AS THE PROJECT IS ACCEPTED BY THE OWNER. THEREAFTER, THE OWNER SHALL BE RESPONSIBLE FOR THE PROPER INSPECTION AND MAINTENANCE OF ANY STORMWATER FACILITIES IN ACCORDANCE WITH THIS OPERATION AND MAINTENANCE PLAN.
2. ALL STRUCTURAL BEST MANAGEMENT PRACTICES (BMP'S), INCLUDING THE SILTATION CONTROL, SHOULD BE INSPECTED AFTER EVERY MAJOR RAINFALL EVENT EXCEEDING 1.0-INCH UNTIL THE SITE IS FULLY STABILIZED TO ENSURE NO SEDIMENTATION INTO THE WETLANDS HAS OCCURRED.
3. THEREAFTER REGULAR BMP INSPECTIONS SHOULD BE CONDUCTED ACCORDING TO THE FOLLOWING SCHEDULE:

BMP STRUCTURE	INSPECTIONS PER YEAR
CRUSHED STONE EDGE DRAIN TRENCHES	2
DETENTION BASINS	2
4. ACCUMULATED SILT AND SEDIMENT AHEAD OF THE SILTATION CONTROLS SHOULD BE REMOVED IF THE ACCUMULATED DEPTH OF SEDIMENT EXCEEDS ONE HALF OF THE HEIGHT OF THE STRUCTURE. ANY ACCUMULATED SILT WITHIN THE DETENTION BASINS SHOULD BE REMOVED ONCE THE ACCUMULATED DEPTH OF SILT EXCEEDS THREE INCHES.
5. ALL REMOVED SEDIMENTS ARE TO BE PROPERLY DISPOSED OF AT A LOCATION TO BE APPROVED BY THE BOARD OF HEALTH, TRANSPORTATION AND DISPOSAL OF SEDIMENTS SHALL COMPLY WITH ALL APPLICABLE LOCAL, STATE, AND FEDERAL REGULATIONS.
6. THE ACCESS DRIVEWAY INTO THE FACILITY SHALL BE FLOWED AFTER ALL SNOW EVENTS TO MAINTAIN EMERGENCY ACCESS TO THE FACILITY. SNOW SHALL BE STOCKPILED WITHIN THE FENCED AREA AND ALLOW TO MELT ON-SITE AND FLOW OVERLAND FOLLOWING NATURAL DRAINAGE PATTERNS.
7. THE ACCESS DRIVEWAY SHALL BE MONITORED ON A REGULAR BASIS TO INSURE ITS SUITABILITY FOR ACCESS. GRAVEL ALONG THE ACCESS DRIVEWAY SHALL BE REPLACED AS NECESSARY TO MAINTAIN SUITABLE ACCESS TO THE ARRAY. IN ADDITION THE ENTIRE FACILITY SHALL BE MONITORED ON A REGULAR BASIS FOR ANY SIGNS OF EROSION DUE TO STORMWATER RUNOFF. ERODED AREAS SHALL BE STABILIZED AS SOON AS POSSIBLE.
8. THE SITE SHALL BE MONITORED TO INSURE PROPOSED DRAINAGE PATTERNS ARE MAINTAINED FOLLOWING CONSTRUCTION. SHOULD CHANNEL FLOW FROM RUNOFF DEVELOP WITHIN THE SITE THAT REQUIRES CORRECTIVE MEASURES, THESE MEASURES SHALL BE REVIEWED WITH THE PLANNING BOARD PRIOR TO THEIR IMPLEMENTATION.
9. SIDE SLOPES AND BOTTOM AREAS OF ANY GRASSED SWALES AND DETENTION BASINS SHOULD BE MOWED TO A MINIMUM HEIGHT OF FOUR INCHES AT LEAST ONCE A YEAR. REMOVE ALL GRASS CLIPPINGS AND ORGANIC MATTER FROM ALL DRAINAGE WAYS AS NECESSARY.
10. THE DETENTION BASINS SHOULD BE INSPECTED FOR TRASH ON A REGULAR BASIS. ANY ACCUMULATED TRASH, LITTER, AND DISCARDED MATERIALS SHOULD BE REMOVED.
11. THE CONTRACTOR AND THE OWNER SHALL MAINTAIN A BMP INSPECTION REPORT FOLLOWING EACH SITE INSPECTION AS RECOMMENDED ABOVE. THE BMP INSPECTION REPORT SHALL IDENTIFY THE DATE OF INSPECTION, THE NAME AND CONTACT NUMBER OF THE RESPONSIBLE PARTY, SPECIFIC STRUCTURES INSPECTED, SPECIFIC MAINTENANCE REQUIRED AND OBSERVATIONS AT A MINIMUM. INSPECTION REPORTS SHOULD ADDRESS THE FOLLOWING CONDITIONS WHERE APPLICABLE:
 1. EMBANKMENT SUBSIDENCE
 2. EROSION
 3. CRACKING OF CONTAINMENT BERM
 4. INLET/OUTLET CONDITIONS
 5. SEDIMENT ACCUMULATIONS
 6. SLOPE STABILITY

EXISTING

100	EXISTING INDEX CONTOUR
98	EXISTING INTERMEDIATE CONTOUR
X 98.8	EXISTING SPOT GRADE
	EXISTING PROPERTY LINE
	EXISTING ABUTTER PROPERTY LINE
□	EXISTING MONUMENT
	EXISTING BUILDING
	EXISTING EDGE OF PAVEMENT
CURB TYPE	EXISTING CURB
SIDEWALK TYPE	EXISTING SIDEWALK
	EXISTING EDGE OF DRIVES
	EXISTING WOOD ROAD
	EXISTING TREELINE
X	EXISTING FENCE LINE
	EXISTING GUARDRAIL
	EXISTING STONEWALL
	EXISTING RETAINING WALL
	EXISTING RAILROAD
	EXISTING SETBACK LINE
	EXISTING EASEMENT LINE
	EXISTING ZONING BOUNDARY
	EXISTING RIP RAP
	EXISTING SOIL BORING LOCATION
	EXISTING TEST PIT LOCATION
	EXISTING SIGN POST
	EXISTING LIGHT POLE
	EXISTING UTILITY POLE
	EXISTING GUY POLE
CB	EXISTING CATCH BASIN
DMH	EXISTING DRAIN MANHOLE
	EXISTING FLARED END
SMH	EXISTING SEWER MANHOLE
WMH	EXISTING WATER MANHOLE
	EXISTING HYDRANT
WV	EXISTING WATER GATE VALVE
CS	EXISTING CURB STOP
	EXISTING WELL LOCATION
EMH	EXISTING ELECTRIC MANHOLE
HH	EXISTING HAND HOLE
T	EXISTING TRANSFORMER PAD
	EXISTING TELEPHONE MANHOLE
	EXISTING CONTROLLER CABINET
GG	EXISTING GAS GATE
SIZE & TYPE	EXISTING DRAIN LINE
SIZE & TYPE	EXISTING SEWER LINE
SIZE & TYPE	EXISTING WATER LINE
SIZE & TYPE	EXISTING GAS LINE
CONDUIT SIZE	EXISTING ELECTRIC LINE
TYPE	EXISTING CABLE T.V. & TELEPHONE
	EXISTING SEPTIC SYSTEM LOCATION
	EXISTING WETLAND LINE
	EXISTING WETLAND FLAG LOCATION
	EXISTING BUFFER LINE
	EXISTING RIVERFRONT LINE
	EXISTING FLOOD ZONE LINE
	EXISTING WATER BODY
	EXISTING EDGE OF LEDGE

LEGEND

PROPOSED

100	PROPOSED INDEX CONTOUR
98	PROPOSED INTERMEDIATE CONTOUR
98.8	PROPOSED SPOT GRADE
	PROPOSED PROPERTY LINE
	PROPOSED MONUMENT
	PROPOSED BUILDING
	PROPOSED EDGE OF PAVEMENT
CURB TYPE	PROPOSED CURB
SIDEWALK TYPE	PROPOSED SIDEWALK
	PROPOSED EDGE GRAVEL DRIVES
	PROPOSED LIMIT OF CLEARING
X	PROPOSED FENCE LINE
	PROPOSED GUARDRAIL
WALL TYPE	PROPOSED WALL
	PROPOSED RETAINING WALL
	PROPOSED RAILROAD
	PROPOSED SETBACK LINE
	PROPOSED EASEMENT LINE
	PROPOSED ZONING BOUNDARY
	PROPOSED RIP RAP
TP	PROPOSED TEST PIT LOCATION
	PROPOSED SIGN POST
	PROPOSED LIGHT POLE
	PROPOSED UTILITY POLE
	PROPOSED GUY POLE
CB	PROPOSED CATCH BASIN
DMH	PROPOSED DRAIN MANHOLE
	PROPOSED FLARED END
SMH	PROPOSED SEWER MANHOLE
WMH	PROPOSED WATER MANHOLE
	PROPOSED HYDRANT
	PROPOSED WATER GATE VALVE
CS	PROPOSED CURB STOP
	PROPOSED WELL LOCATION
EMH	PROPOSED ELECTRIC MANHOLE
HH	PROPOSED HAND HOLE
T	PROPOSED TRANSFORMER PAD
	PROPOSED TELEPHONE MANHOLE
	PROPOSED CONTROLLER CABINET
GG	PROPOSED GAS GATE
SIZE & TYPE	PROPOSED DRAIN LINE
SIZE & TYPE	PROPOSED SEWER LINE
SIZE & TYPE	PROPOSED WATER LINE
SIZE & TYPE	PROPOSED GAS LINE
CONDUIT SIZE	PROPOSED ELECTRIC LINE
TYPE	PROPOSED CABLE T.V. & TELEPHONE
	PROPOSED SEPTIC SYSTEM LOCATION
	PROPOSED WETLAND REPLICATION AREA
	PROPOSED SILTATION CONTROL
LOC	PROPOSED LIMIT OF CLEARING
(DEM)	EXISTING STRUCTURE TO BE DEMOLISHED
(R&D)	REMOVE & DISPOSE
(R&R)	REMOVE & RESET
(AG)	ADJUST TO GRADE
(AB)	ABANDON
(AIP)	ABANDON IN PLACE

FIELD ENGINEERING CO., INC. CONSULTING ENGINEERS

110 INDUSTRIAL DRIVE
P.O. BOX 1178
MATTAPAN, MA 02739
TEL: (508) 758-2749
FAX: (508) 758-2849


THE CROCKER BUILDING
4 COURT STREET, SUITE 104
TAUNTON, MA 02780
TEL: (508) 824-9279
FAX: (508) 824-9276

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Revisions			
No.	Description	Date	App'd
5	ADD SHEET 14 PER PB DECISION ISSUED FOR CONSTRUCTION	10/3/16	RRR
4	REVIS FOR NEW ACCESS ROAD	9/1/16	RRR
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1	REV PER PB COMMENT LETTERS	10/5/15	RRR
No.	Description	Date	App'd

Date	8/12/15	
Scale	NO SCALE	
Drawn By	Designed By	Checked By
RMS	RRR	RRR

ISSUED FOR PERMITTING

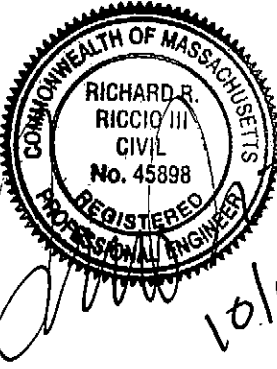

PROPOSED SITE DEVELOPMENT
CEC SOLAR #1056 LLC
207 PROVIDENCE ROAD
GRAFTON, MASSACHUSETTS

Drawing Title	
NOTES & LEGEND	
Project No.	Sheet
2035	2 of 14

N-1

NOTES:

1. THE SUBJECT PARCEL IS SHOWN AS PARCEL 10 ON GRAFTON ASSESSORS MAP 99.
2. THE TOPOGRAPHY AND EXISTING CONDITIONS AS SHOWN ARE FROM AN ON THE GROUND SURVEY PERFORMED BY MADDIGAN LAND SURVEYING ON VARIOUS DATES IN JUNE AND JULY 2015.
3. THE SUBJECT PARCEL IS LOCATED WITHIN ZONE X, AREAS DETERMINED TO BE OUTSIDE THE 0.2% ANNUAL CHANCE FLOODPLAIN AS SHOWN ON THE FIRM, COMMUNITY-PANEL NUMBER 25027C0841E EFFECTIVE DATE JULY 4, 2011.
4. OWNERS OF THE ADJUTING PROPERTIES AS SHOWN ARE ACCORDING TO THE CURRENT TOWN OF GRAFTON ASSESSORS RECORDS.
5. THE EXISTING PROPERTY LINES SHOWN ON THIS PLAN WERE PREVIOUSLY APPROVED ON AN APPROVAL NOT REQUIRED PLAN PREPARED FOR CEC SOLAR #1056 LLC, PREPARED BY FIELD ENGINEERING CO. INC. DATED 6/15/15. SAID PLAN WAS ENDORSED BY THE TOWN OF GRAFTON PLANNING BOARD ON 6/23/15 AND IS RECORDED AT THE WORCESTER COUNTY REGISTRY OF DEEDS IN PLAN BOOK 922, PAGE 105.

99/9
N/F
HILLVIEW ESTATES INC. TRUSTEE

99/10A
N/F
JOHN D. & KIMBERLY KELL

99/10
N/F
ROBERT & KAREN KELL
LOT A
4.9 ± ACRES
254.88' FRONTAGE

SOIL OBSERVATION LOG

DATE: 10/15/15

SOIL EVALUATOR: RICHARD R. RICCIO III, P.E.

TEST PIT #1

TOP ELEVATION: 188.0±

0"-9"	O/A	SANDY LOAM 10 YR 3/2	ELEV. 187.3±
9"-24"	B	SANDY LOAM 10 YR 4/6	ELEV. 186.0±
24"-84"	C	COARSE SANDY LOAM 2.5 Y 5/4	ELEV. 181.0±

OBSERVED DEPTH TO WEeping - N/E
ESTIMATED DEPTH TO SEASONAL HIGH
GROUNDWATER - 36" (MOTTLE DEPTH @ ELEV. 185.0±)

SOIL OBSERVATION LOG

DATE: 10/15/15

SOIL EVALUATOR: RICHARD R. RICCIO III, P.E.

TEST PIT #2

TOP ELEVATION: 189.0±

0"-8"	O/A	SANDY LOAM 10 YR 3/2	ELEV. 188.3±
8"-22"	B	SANDY LOAM 10 YR 4/6	ELEV. 187.2±
22"-80"	C	SANDY LOAM 2.5 Y 6/4	ELEV. 182.3±

OBSERVED DEPTH TO WEeping - N/E
ESTIMATED DEPTH TO SEASONAL HIGH
GROUNDWATER - 40" (MOTTLE DEPTH @ ELEV. 185.7±)

SOIL OBSERVATION LOG

DATE: 10/15/15

SOIL EVALUATOR: RICHARD R. RICCIO III, P.E.

TEST PIT #4

TOP ELEVATION: 164.5±

0"-7"	O/A	SANDY LOAM 10 YR 3/2	ELEV. 163.9±
7"-33"	B	SANDY LOAM 10 YR 4/6	ELEV. 161.8±
33"-60"	C	SANDY LOAM 2.5 Y 6/4	ELEV. 159.5±

OBSERVED DEPTH TO WEeping - N/E
ESTIMATED DEPTH TO SEASONAL HIGH
GROUNDWATER - 34" (MOTTLE DEPTH @ ELEV. 161.7±)

SOIL OBSERVATION LOG

DATE: 10/15/15

SOIL EVALUATOR: RICHARD R. RICCIO III, P.E.

TEST PIT #3

TOP ELEVATION: 164.5±


0"-8"	O/A	SANDY LOAM 10 YR 3/2	ELEV. 163.8±
8"-30"	B	SANDY LOAM 10 YR 4/6	ELEV. 162.0±
30"-56"	C	SANDY LOAM 2.5 Y 6/4	ELEV. 159.8±

OBSERVED DEPTH TO WEeping - N/E
ESTIMATED DEPTH TO SEASONAL HIGH
GROUNDWATER - 36" (MOTTLE DEPTH @ ELEV. 161.5±)

I HEREBY CERTIFY THAT THE PROPERTY LINES SHOWN ON THIS PLAN ARE THE LINES DIVIDING EXISTING OWNERSHIPS, AND THE LINES OF THE STREETS AND WAYS SHOWN ARE THOSE OF PUBLIC OR PRIVATE STREETS OR WAYS ALREADY ESTABLISHED, AND THAT NO NEW LINES FOR DIVISION OF EXISTING OWNERSHIP OR FOR NEW WAYS ARE SHOWN. (MASS GENERAL LAWS CHAPTER 41, SECTION 81-X)


I FURTHER CERTIFY THAT THIS PLAN CONFORMS TO THE RULES AND REGULATIONS OF THE REGISTERS OF DEEDS OF THE COMMONWEALTH OF MASSACHUSETTS.

David J. Maddigan, Jr. 10-19-16
PROFESSIONAL LAND SURVEYOR DATE

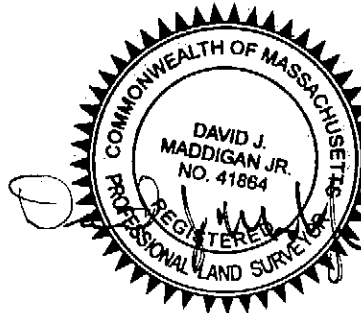

PLAN BOOK 923 PLAN 10
SHEET 3 OF 14

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P.O. BOX 1178
MATTAPAN, MA 02739
TEL: (508) 758-2749
FAX: (508) 758-2849

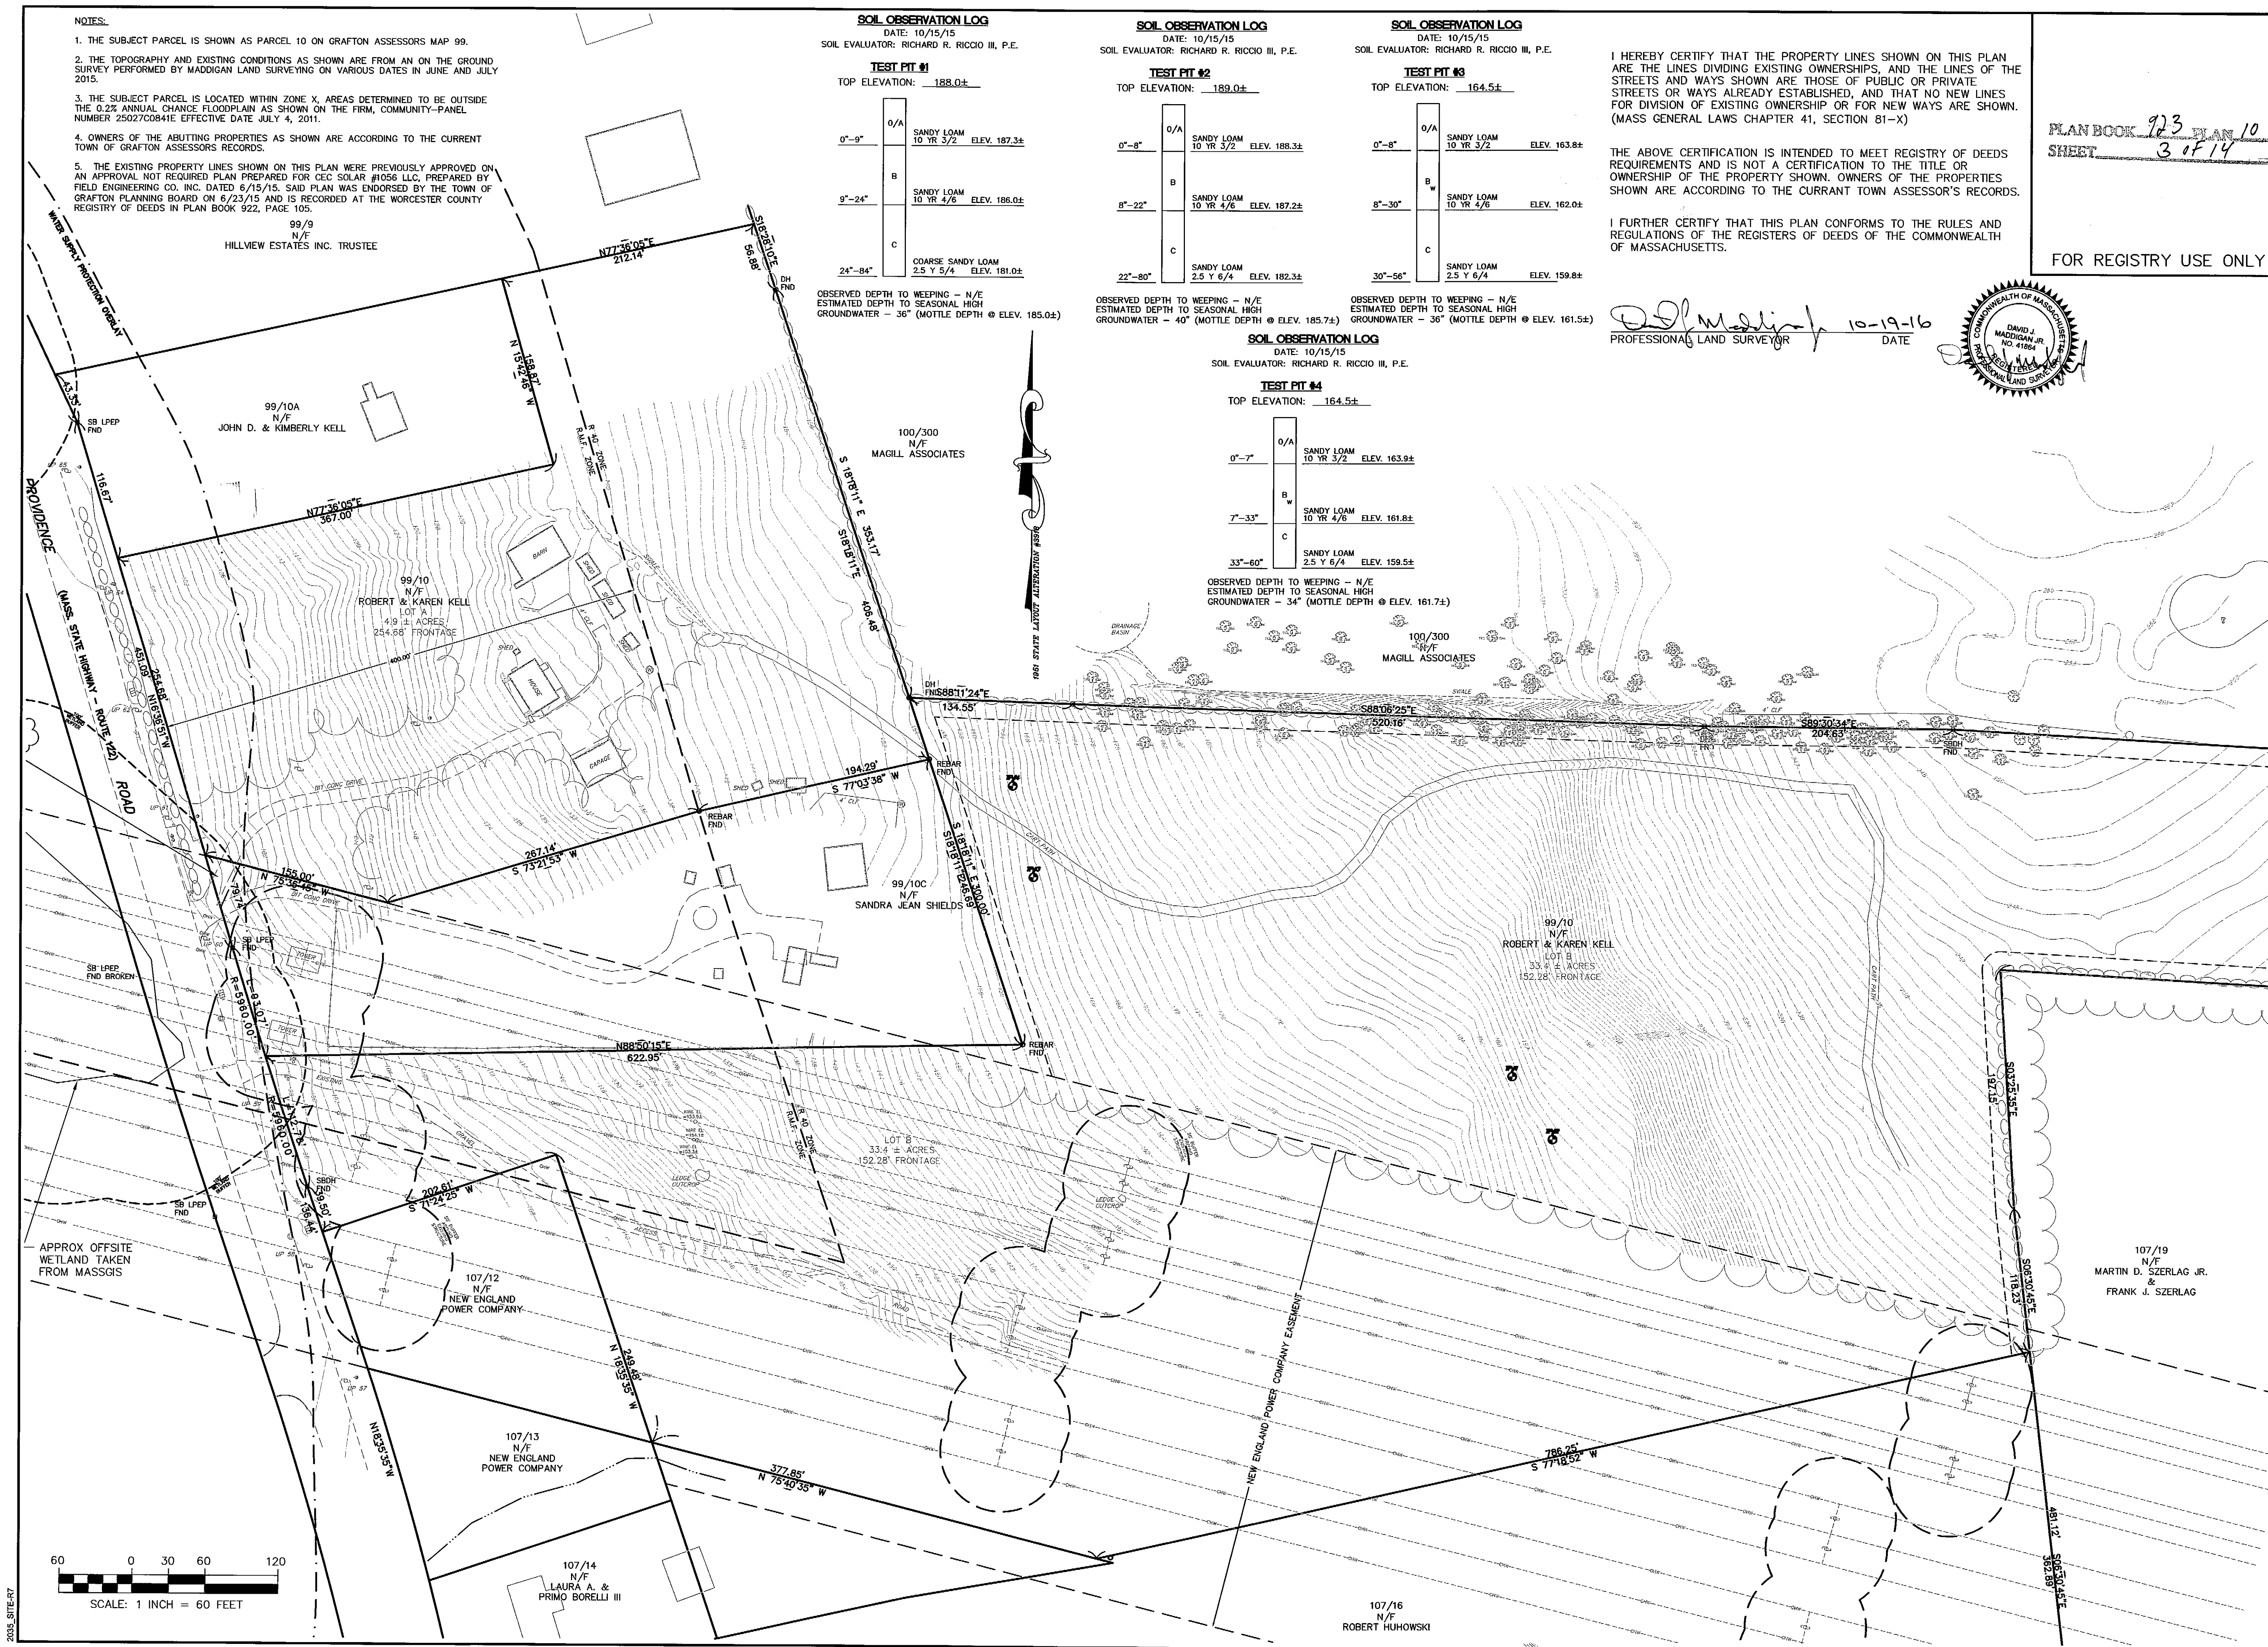THE CROCKER BUILDING
4 COURT STREET SUITE 104
TAUNTON, MA 02780
TEL: (508) 824-9279
FAX: (508) 824-9276

Revisions

No.	Description	Date	Appvd.
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1	REV PER PB COMMENT LETTERS	10/15/16	RRR


Date 8/12/15

Scale 1"=60'

Drawn By	Designed By	Checked By
RMS	RRR	RRR

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PROPOSED SITE DEVELOPMENT
CEC SOLAR #1056 LLC

207 PROVIDENCE ROAD
GRAFTON, MASSACHUSETTS

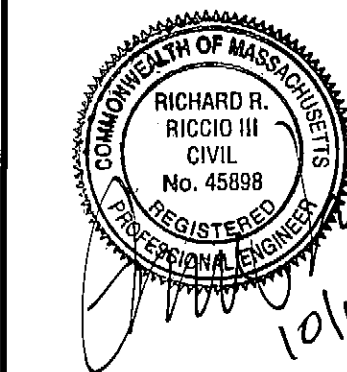Drawing Title

EXISTING CONDITIONS


Project No.

2035

Sheet

3 OF 14

EC-1

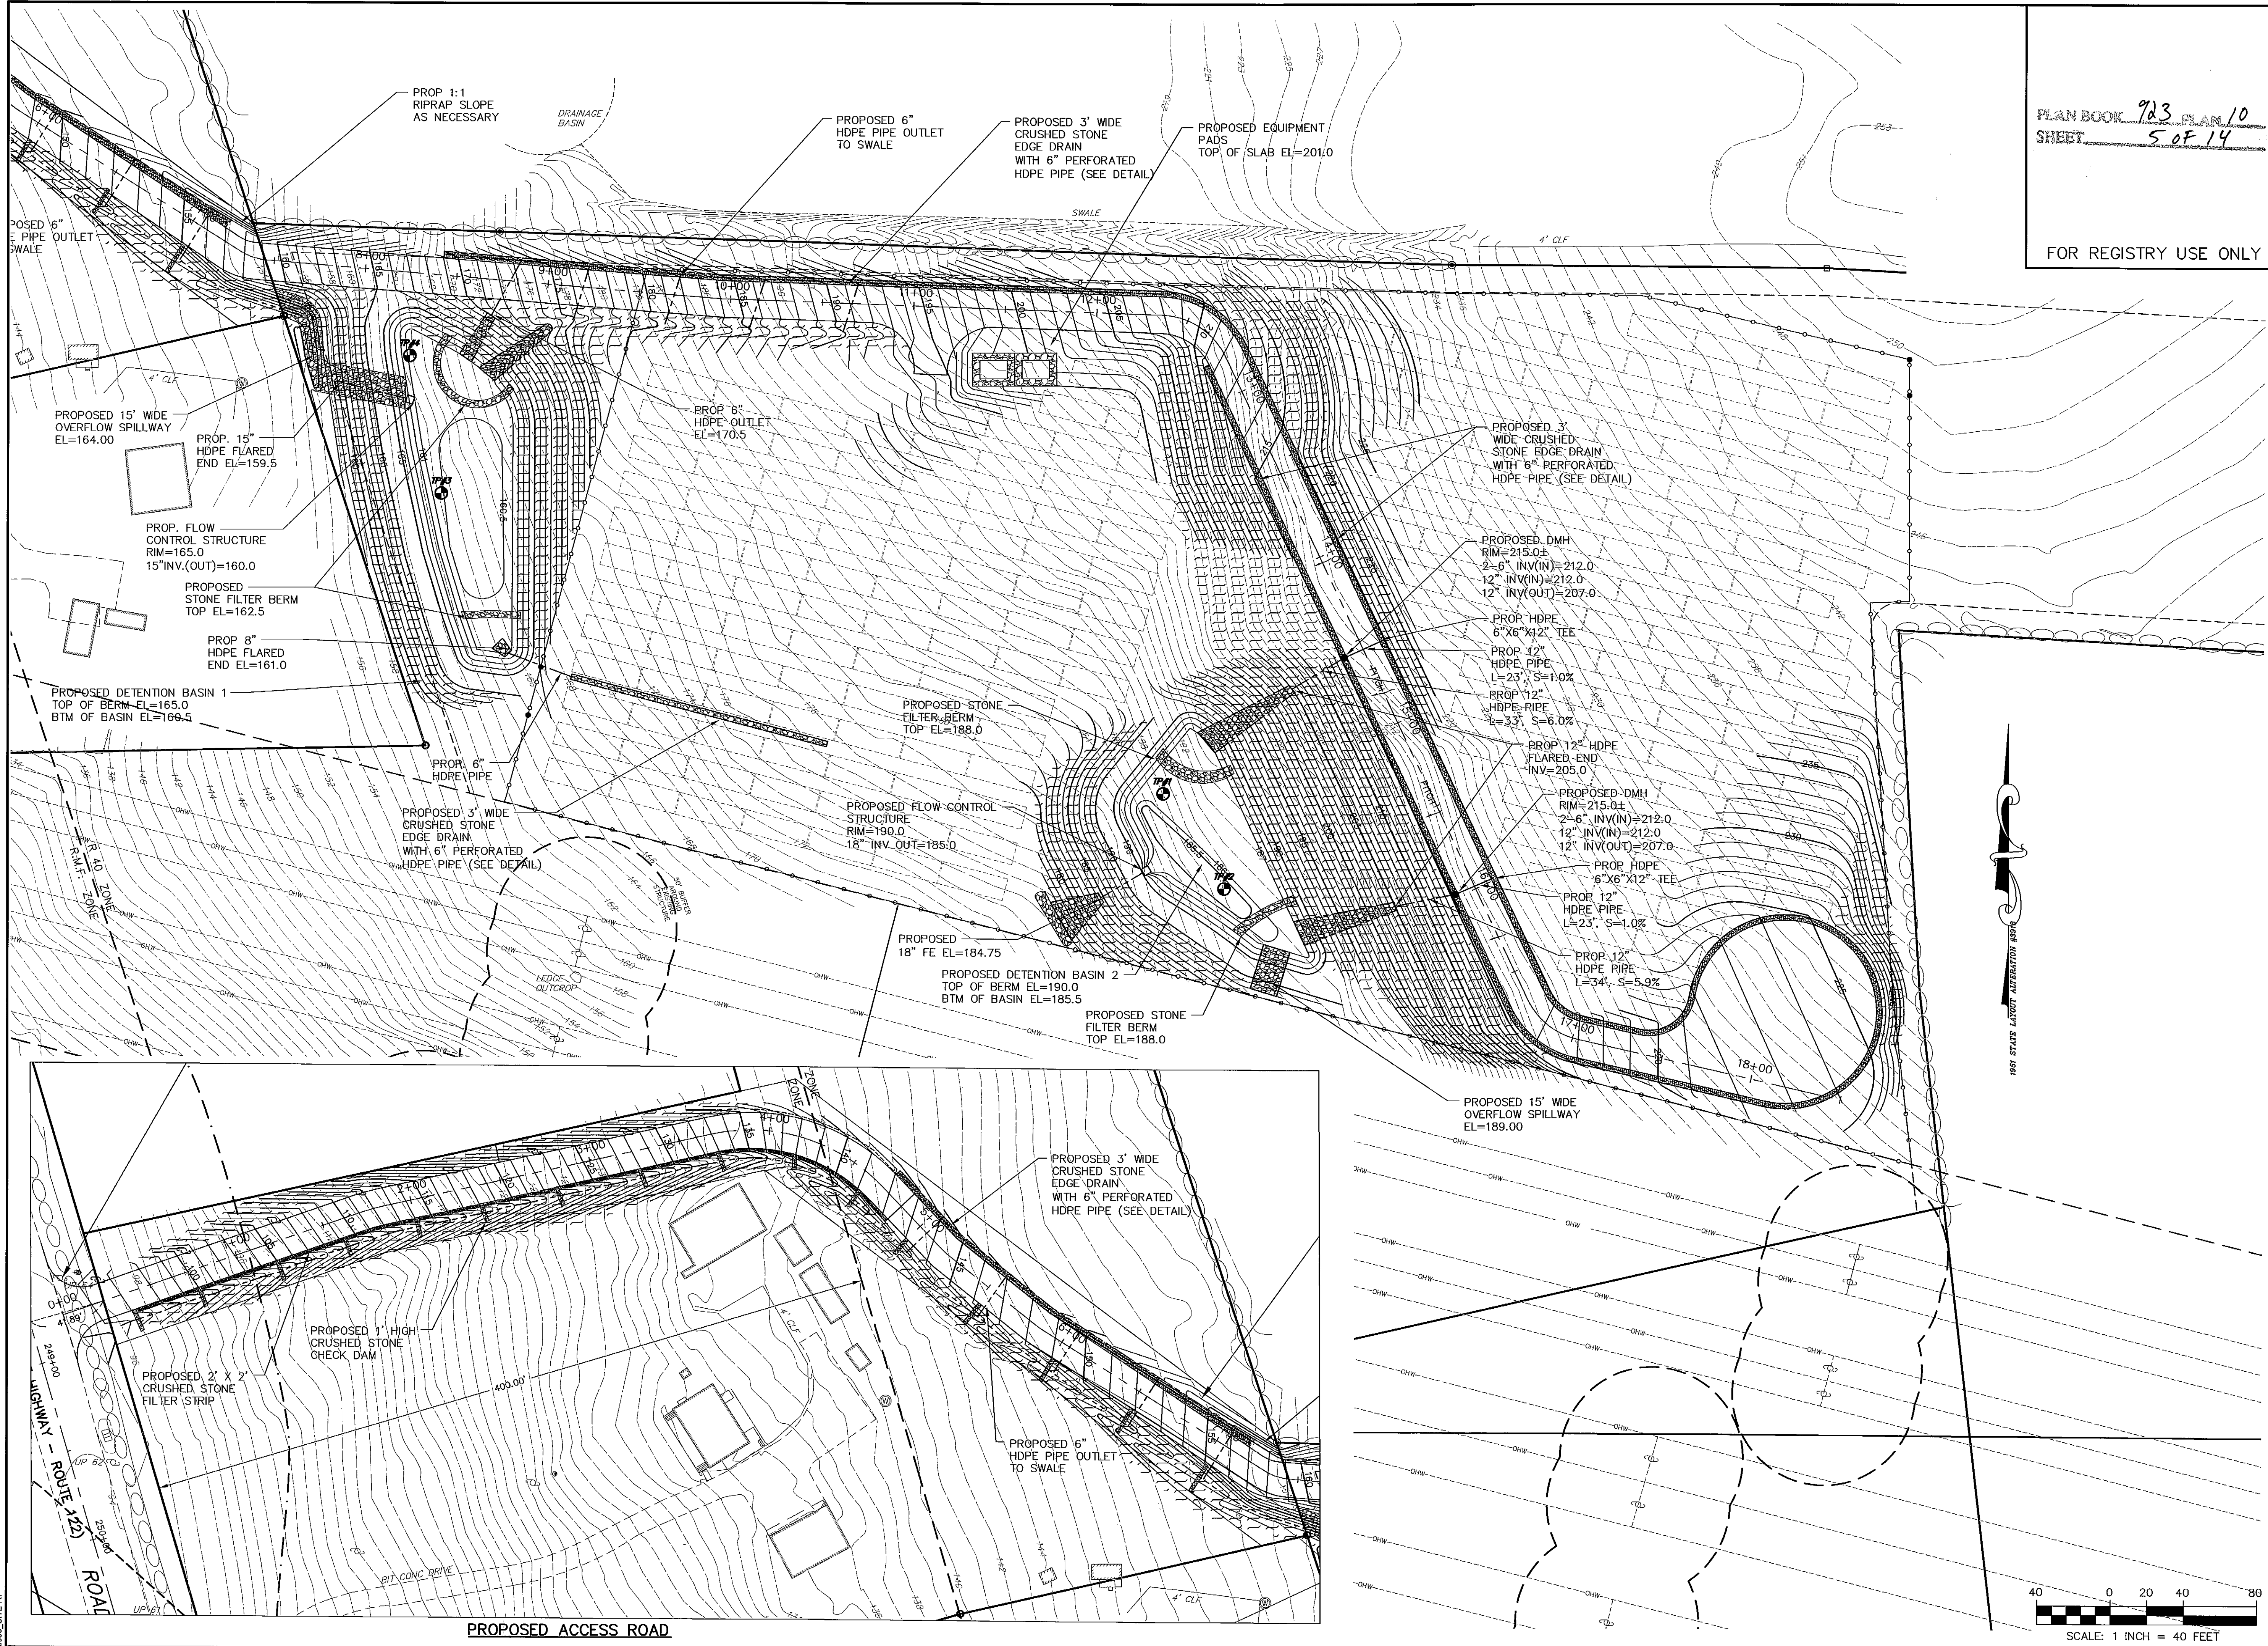

PLAN BOOK 923 PLAN 10
SHEET 5 OF 14

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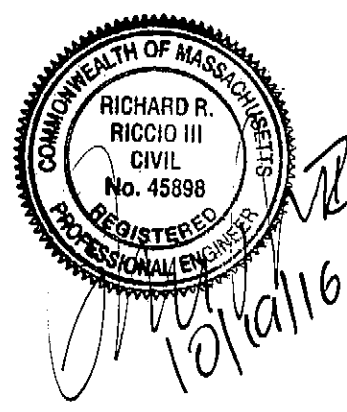
FIELD ENGINEERING CO., INC.
CONSULTING ENGINEERS

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Date		8/12/15		

Scale			1"=40'
Drawn By	Designed By	Checked By	
RMS	RRR	RRR	
Issued For			
PERMITTING			




PROPOSED SITE DEVELOPMENT
CEC SOLAR #1056 LLC


207 PROVIDENCE ROAD
GRAFTON, MASSACHUSETTS

Drawing Title	
SOLAR ARRAY GRADING & DRAINAGE	
Project No.	Sheet
2035	5 OF 14


SGD-1

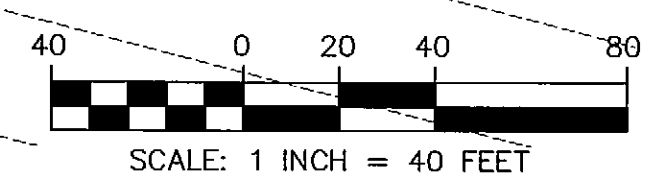

2035 SITE-R7

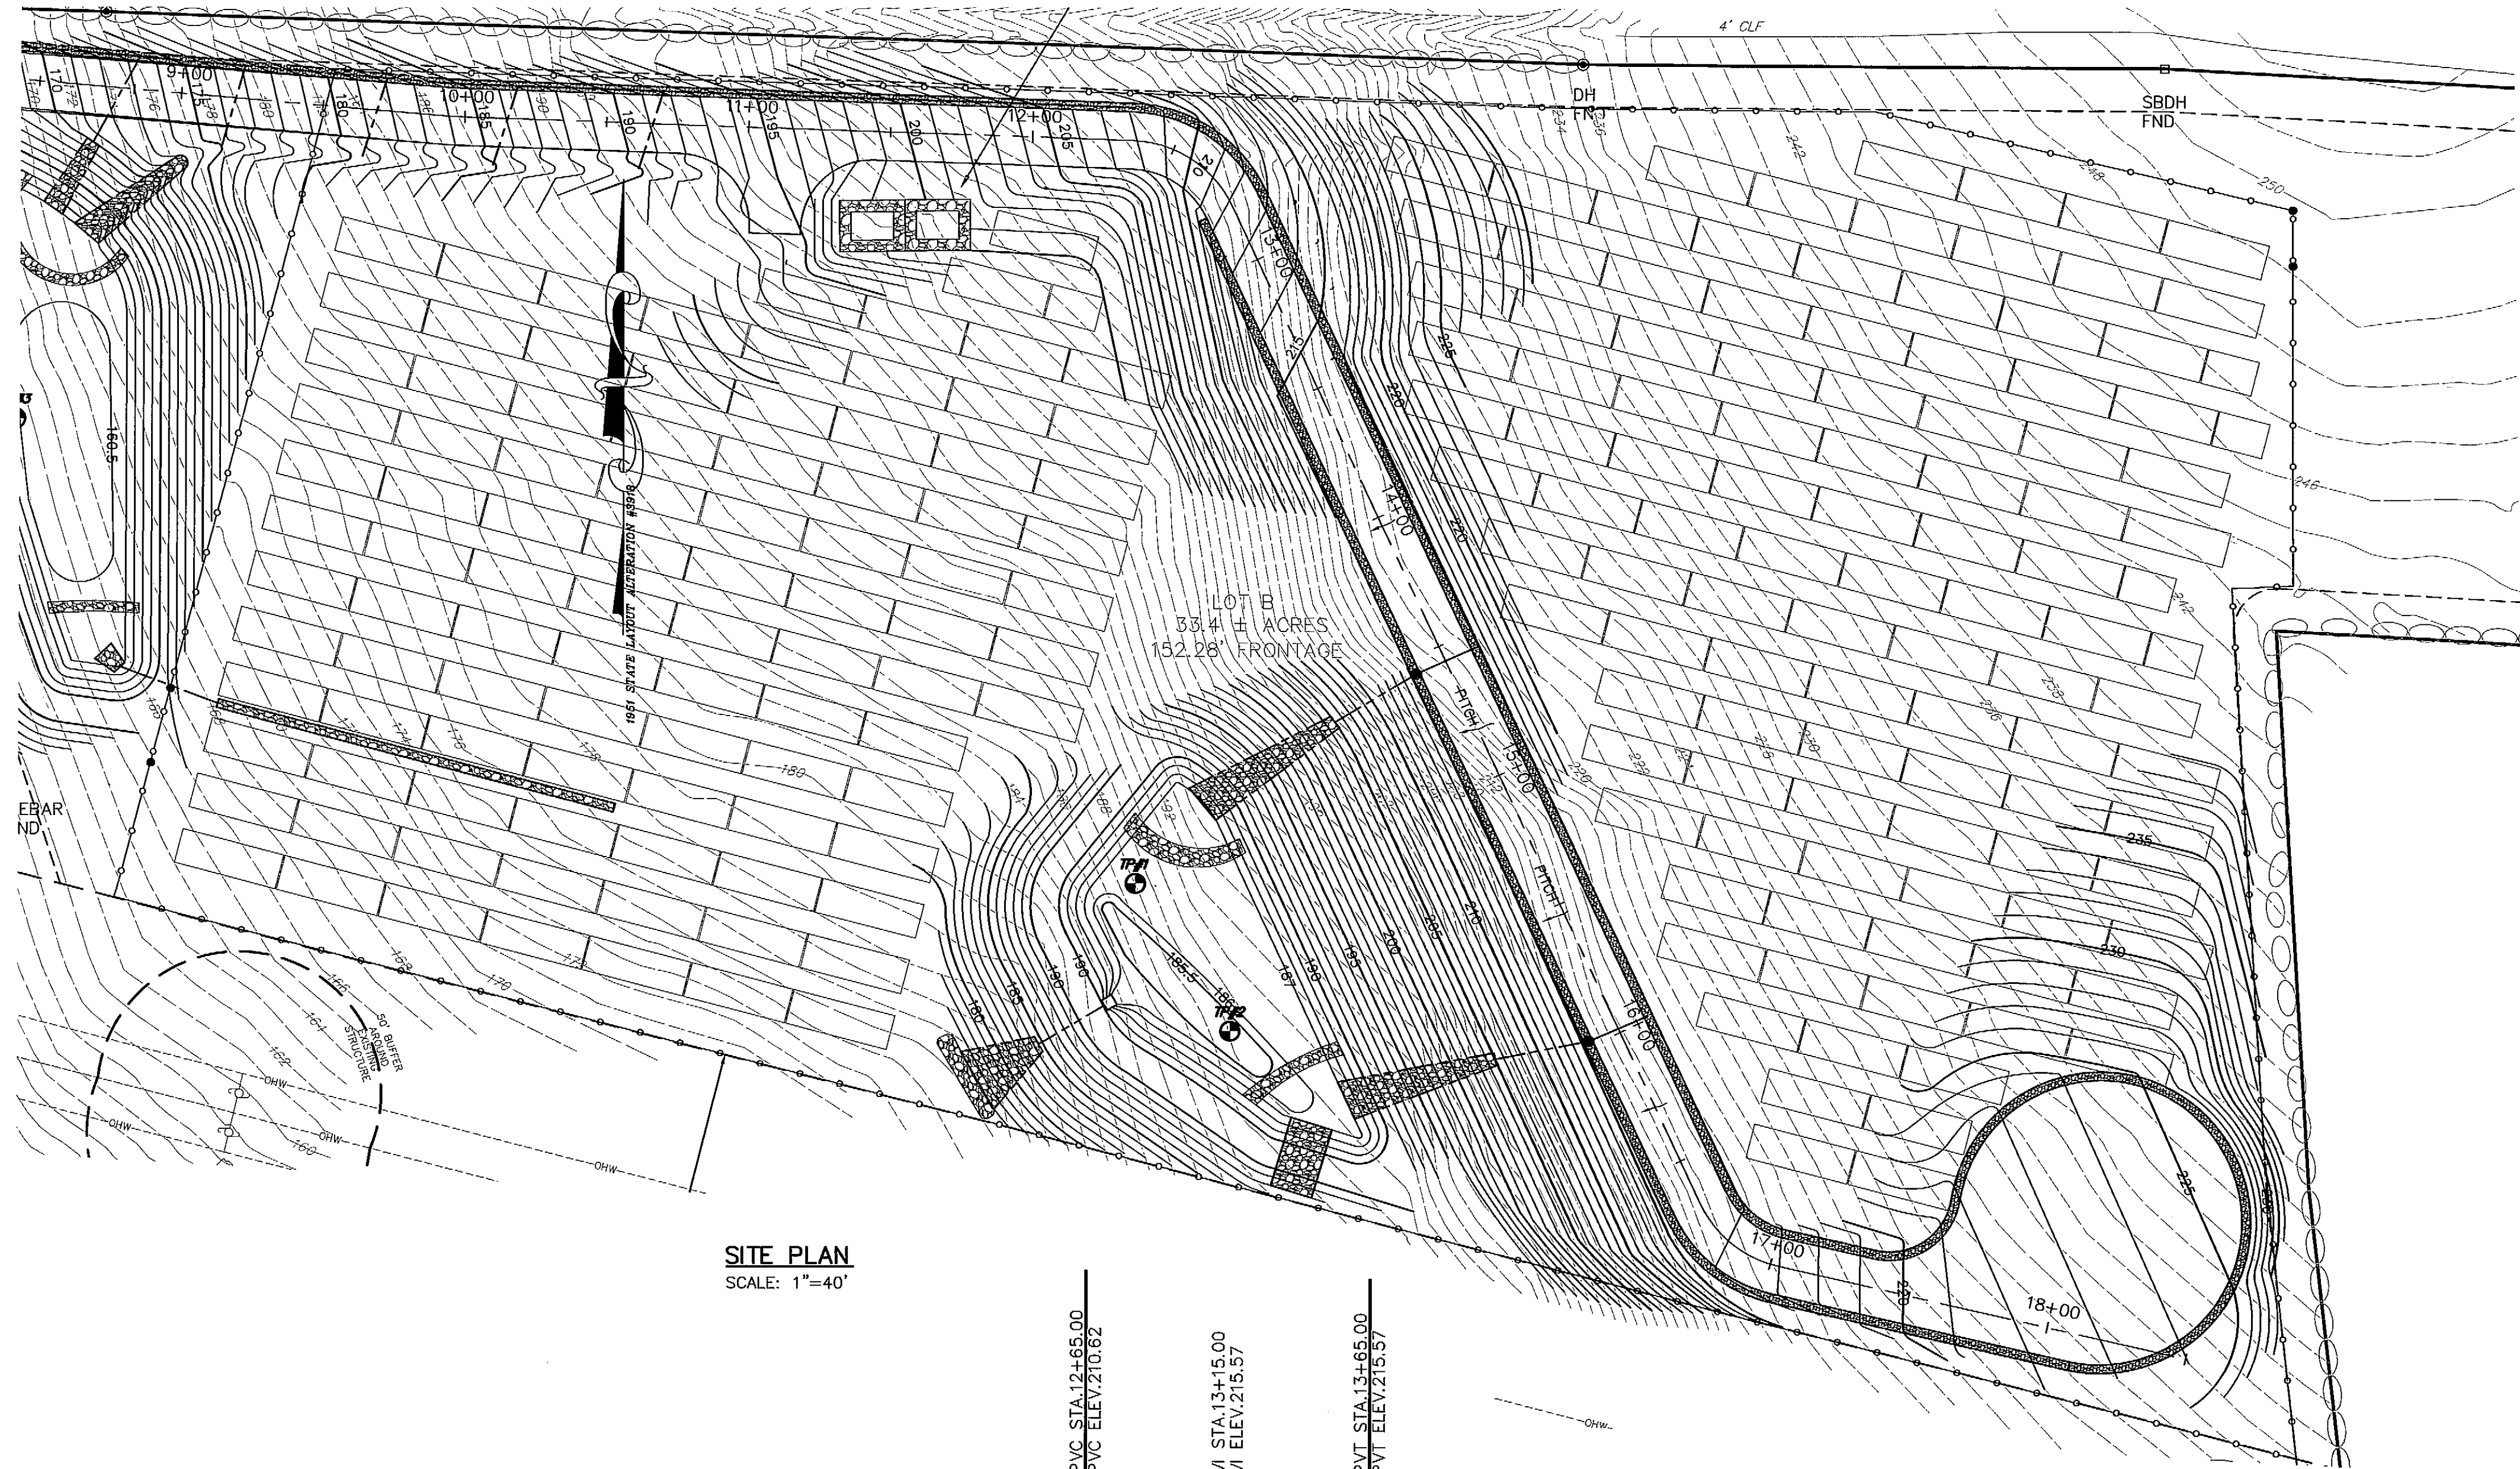

SITE PLAN
SCALE: 1"=40'

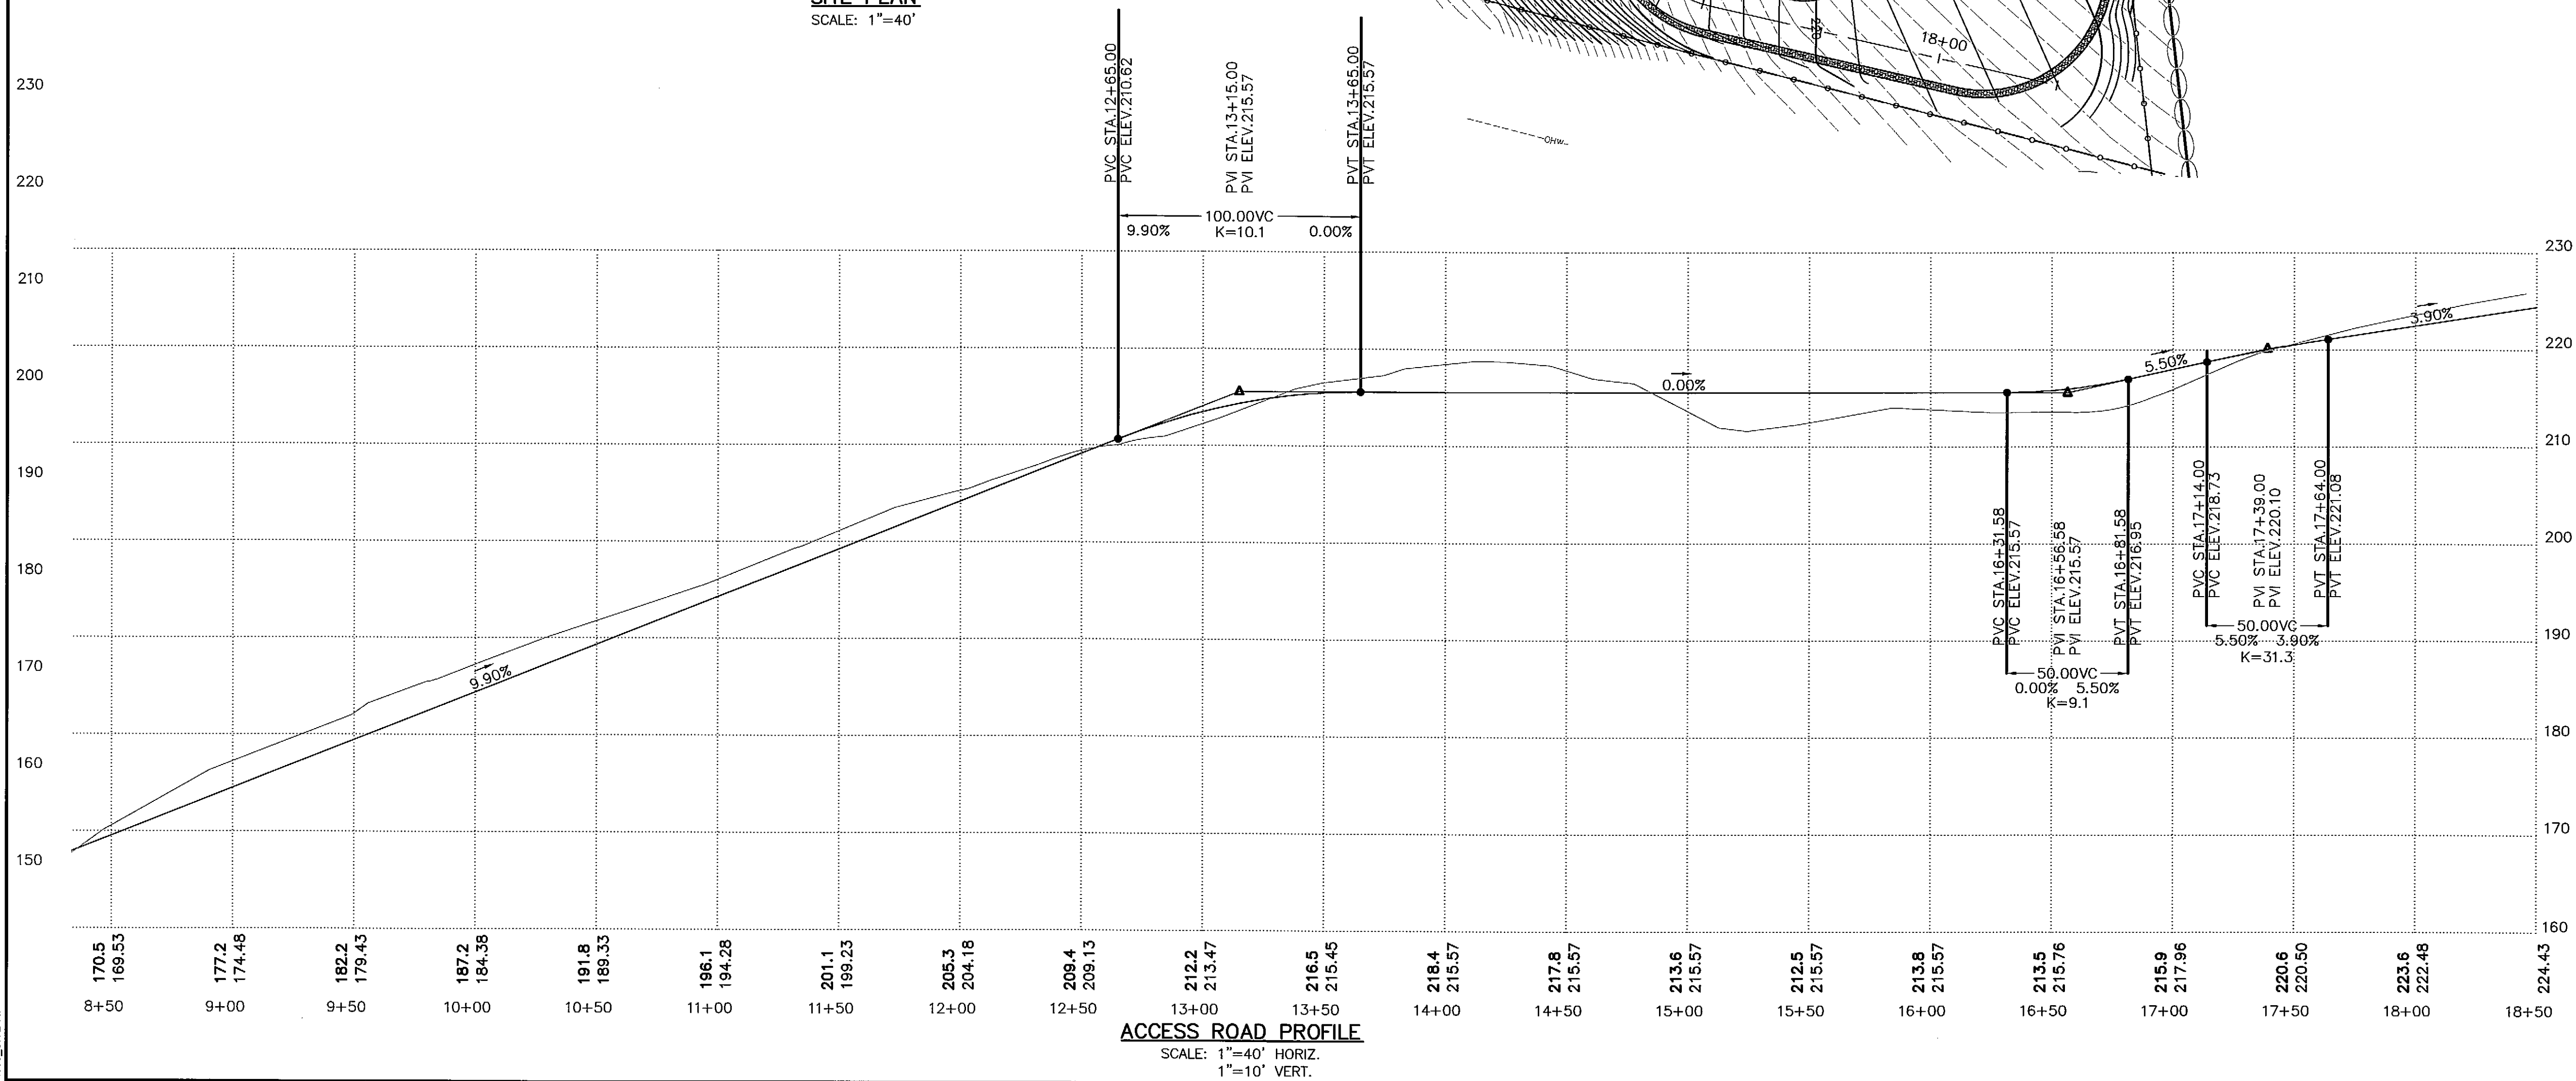

ACCESS ROAD PROFILE
SCALE: 1"=40' HORIZ.
1"=10' VERT.

PLAN BOOK 923 PLAN 10
SHEET 7 OF 14

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CO., INC.
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110 INDUSTRIAL DRIVE
P.O. BOX 1178
MATTAPAN, MA 02739
TEL: (508) 758-2748
FAX: (508) 758-2849

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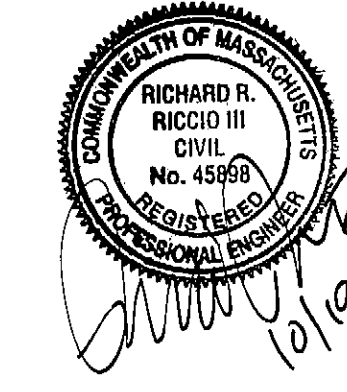
Revisions				
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1	COMMENT LETTERS	10/5/15	RRR	
No.	Description	Date	Appvd.	

Date 8/12/15

Scale 1"=40'

Drawn By RMS	Designed By RRR	Checked By RRR
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Issued For
PERMITTING




PROPOSED SITE DEVELOPMENT
CEC SOLAR #1056 LLC
207 PROVIDENCE ROAD
GRAFTON, MASSACHUSETTS

Drawing Title
ACCESS ROAD
PLAN & PROFILE

Project No. 2035	Sheet 7 OF 14
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PP-2

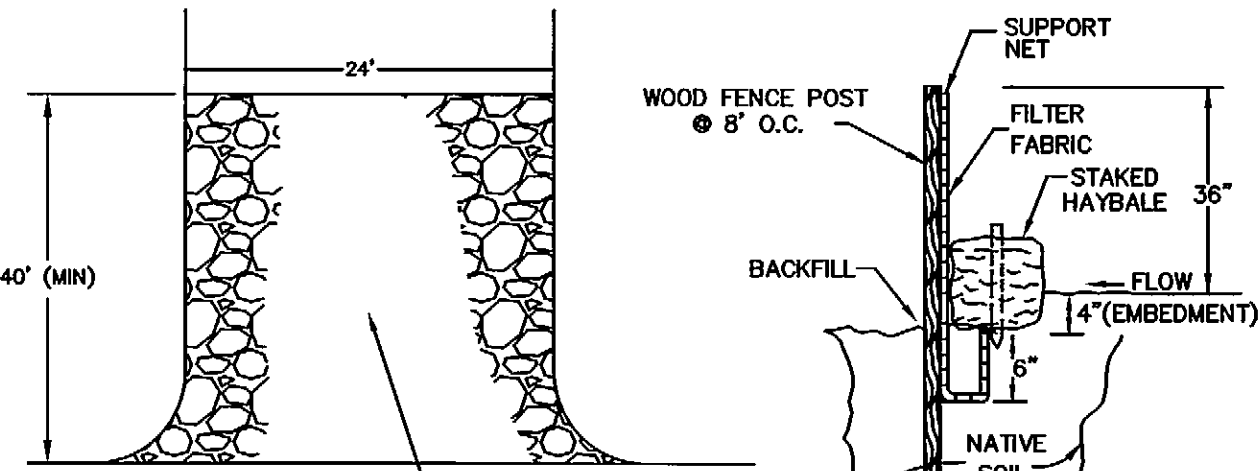



TEMPORARY CONSTRUCTION PAD
NOT TO SCALE

NOTE: TEMPORARY CONSTRUCTION PADS TO BE PLACED AT ALL CONSTRUCTION ENTRANCES TO MINIMIZE TRACKING ONTO THE ROADWAY SURFACE.


TYPICAL HAY BALE/
SILT FENCE DETAIL

NOT TO SCALE


- DEWATERING SPECIFICATIONS
1. DEWATERING BASINS SHALL BE CONSTRUCTED BEFORE ANY DEWATERING OPERATION COMMENCE. DISCHARGE FROM THE DEWATERING BASINS SHALL BE DIRECTED TO THE NEAREST WETLAND DISCHARGE AREA.
 2. HAY BALES/SILT DEWATERING BASINS SHALL BE CONSTRUCTED BEFORE DEWATERING BEGINS.
 3. ALL SEDIMENT SHALL BE REMOVED AND FINISHED GRADES RESTORED UPON COMPLETION OF DEWATERING OPERATIONS.
 4. THE LOCATION OF ANY DEWATERING BASIN SHALL BE REVIEWED WITH THE PROJECT ENGINEER AND CONSERVATION COMMISSION AGENT PRIOR TO THEIR IMPLEMENTATION.

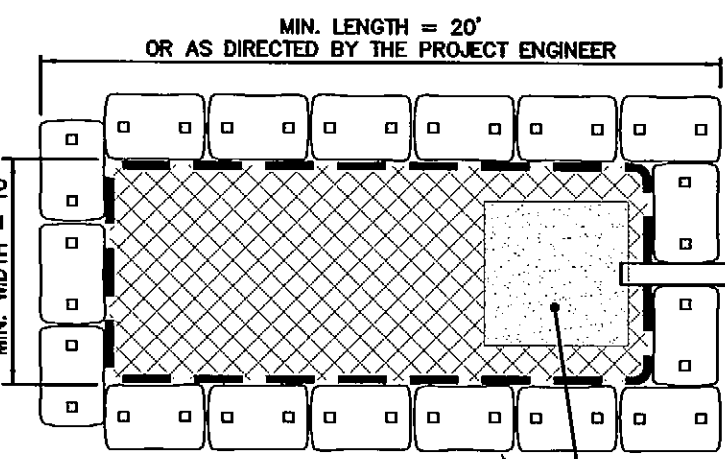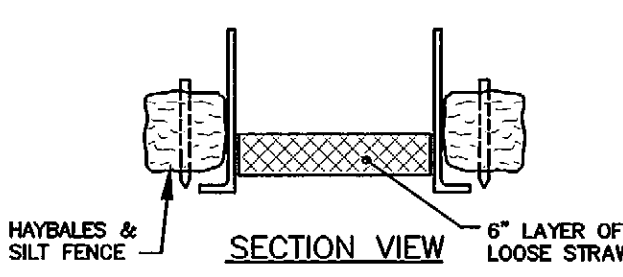

DEWATERING BASIN
NOT TO SCALE


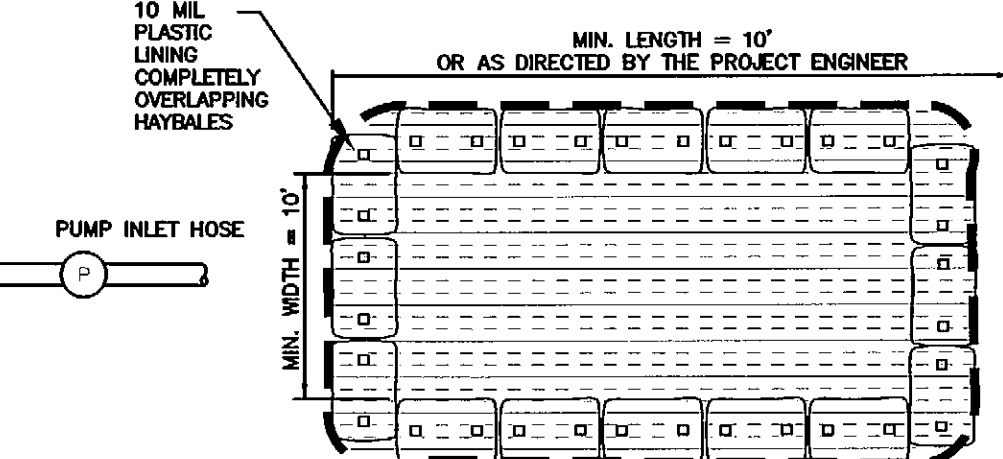


CONCRETE
WASHOUT AREA
NOT TO SCALE

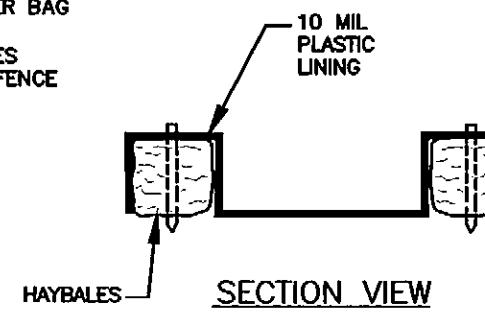

PHASING NOTES

1. INSTALL PROPOSED SILTATION CONTROL MEASURES AS SHOWN ON THESE PLANS. (REFER TO EROSION AND SEDIMENTATION CONTROL PROGRAM ON SHEET N-1 FOR ADDITIONAL INFORMATION ON SILTATION CONTROL PRACTICES TO BE USED THROUGHOUT THE SITE)
2. CONSTRUCT CRUSHED STONE TRACKING PADS PRIOR TO ANY EARTHWORK OR TREE CLEARING BEING PERFORMED.
3. NOTIFY CONSERVATION COMMISSION AGENT FOLLOWING INSTALLATION OF SILTATION CONTROL, PRIOR TO ANY MAJOR EXCAVATION TAKING PLACE.
4. CLEAR AND GRUB SITE. TREES SHALL BE CHIPPED ON-SITE AND MULCH SHALL BE STOCKPILED FOR USE TO TEMPORARILY STABILIZE EXPOSED SURFACES.
5. CONSTRUCT TEMPORARY DIVERSION SWALES WITH HAY BALE CHECK DAMS AS NECESSARY, CONSTRUCTED PROPOSED DETENTION AREAS AND SEDIMENT FOREBAYS TO BE USED AS SEDIMENT BASINS DURING CONSTRUCTION.
6. CONSTRUCT PAVED ACCESS DRIVE AND ASSOCIATED DRAINAGE BMPs EARLY ON IN CONSTRUCTION SEQUENCE TO SERVE AS STABILIZED CONSTRUCTION ENTRANCE INTO THE SITE. PAVED PORTION OF ACCESS DRIVE SHOULD BE PAVED PRIOR TO WINTER BATCH PLANT SHUTDOWN.
7. PERFORM NECESSARY SITE GRADING, CONSTRUCT ON-SITE GRAVEL ACCESS ROADS. LOAM, COMPACT AND ROLL SITE FOR TEMPORARY STABILIZATION.
8. INSTALL SOLAR ARRAY FOUNDATIONS, CONCRETE PADS, AND SOLAR PANELS.
9. FINE GRADE, LOAM DISTURBED AREAS AS NECESSARY AND SEED SITE FOLLOWING INSTALLATION OF PANELS.
10. CONNECT DESIGNED DRAINAGE STRUCTURES AND FILL TEMPORARY SWALES AND SEDIMENT BASINS WHERE APPLICABLE.
11. REMOVE ANY SEDIMENT FROM DETENTION AREAS USED AS TEMPORARY SEDIMENT BASINS PRIOR TO FINAL LOAMING AND SEEDING OF THESE AREAS.
12. REMOVE SILTATION CONTROLS UPON FULL STABILIZATION OF FINISHED SURFACES.

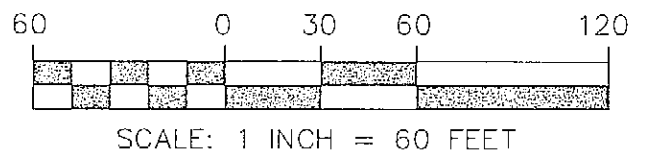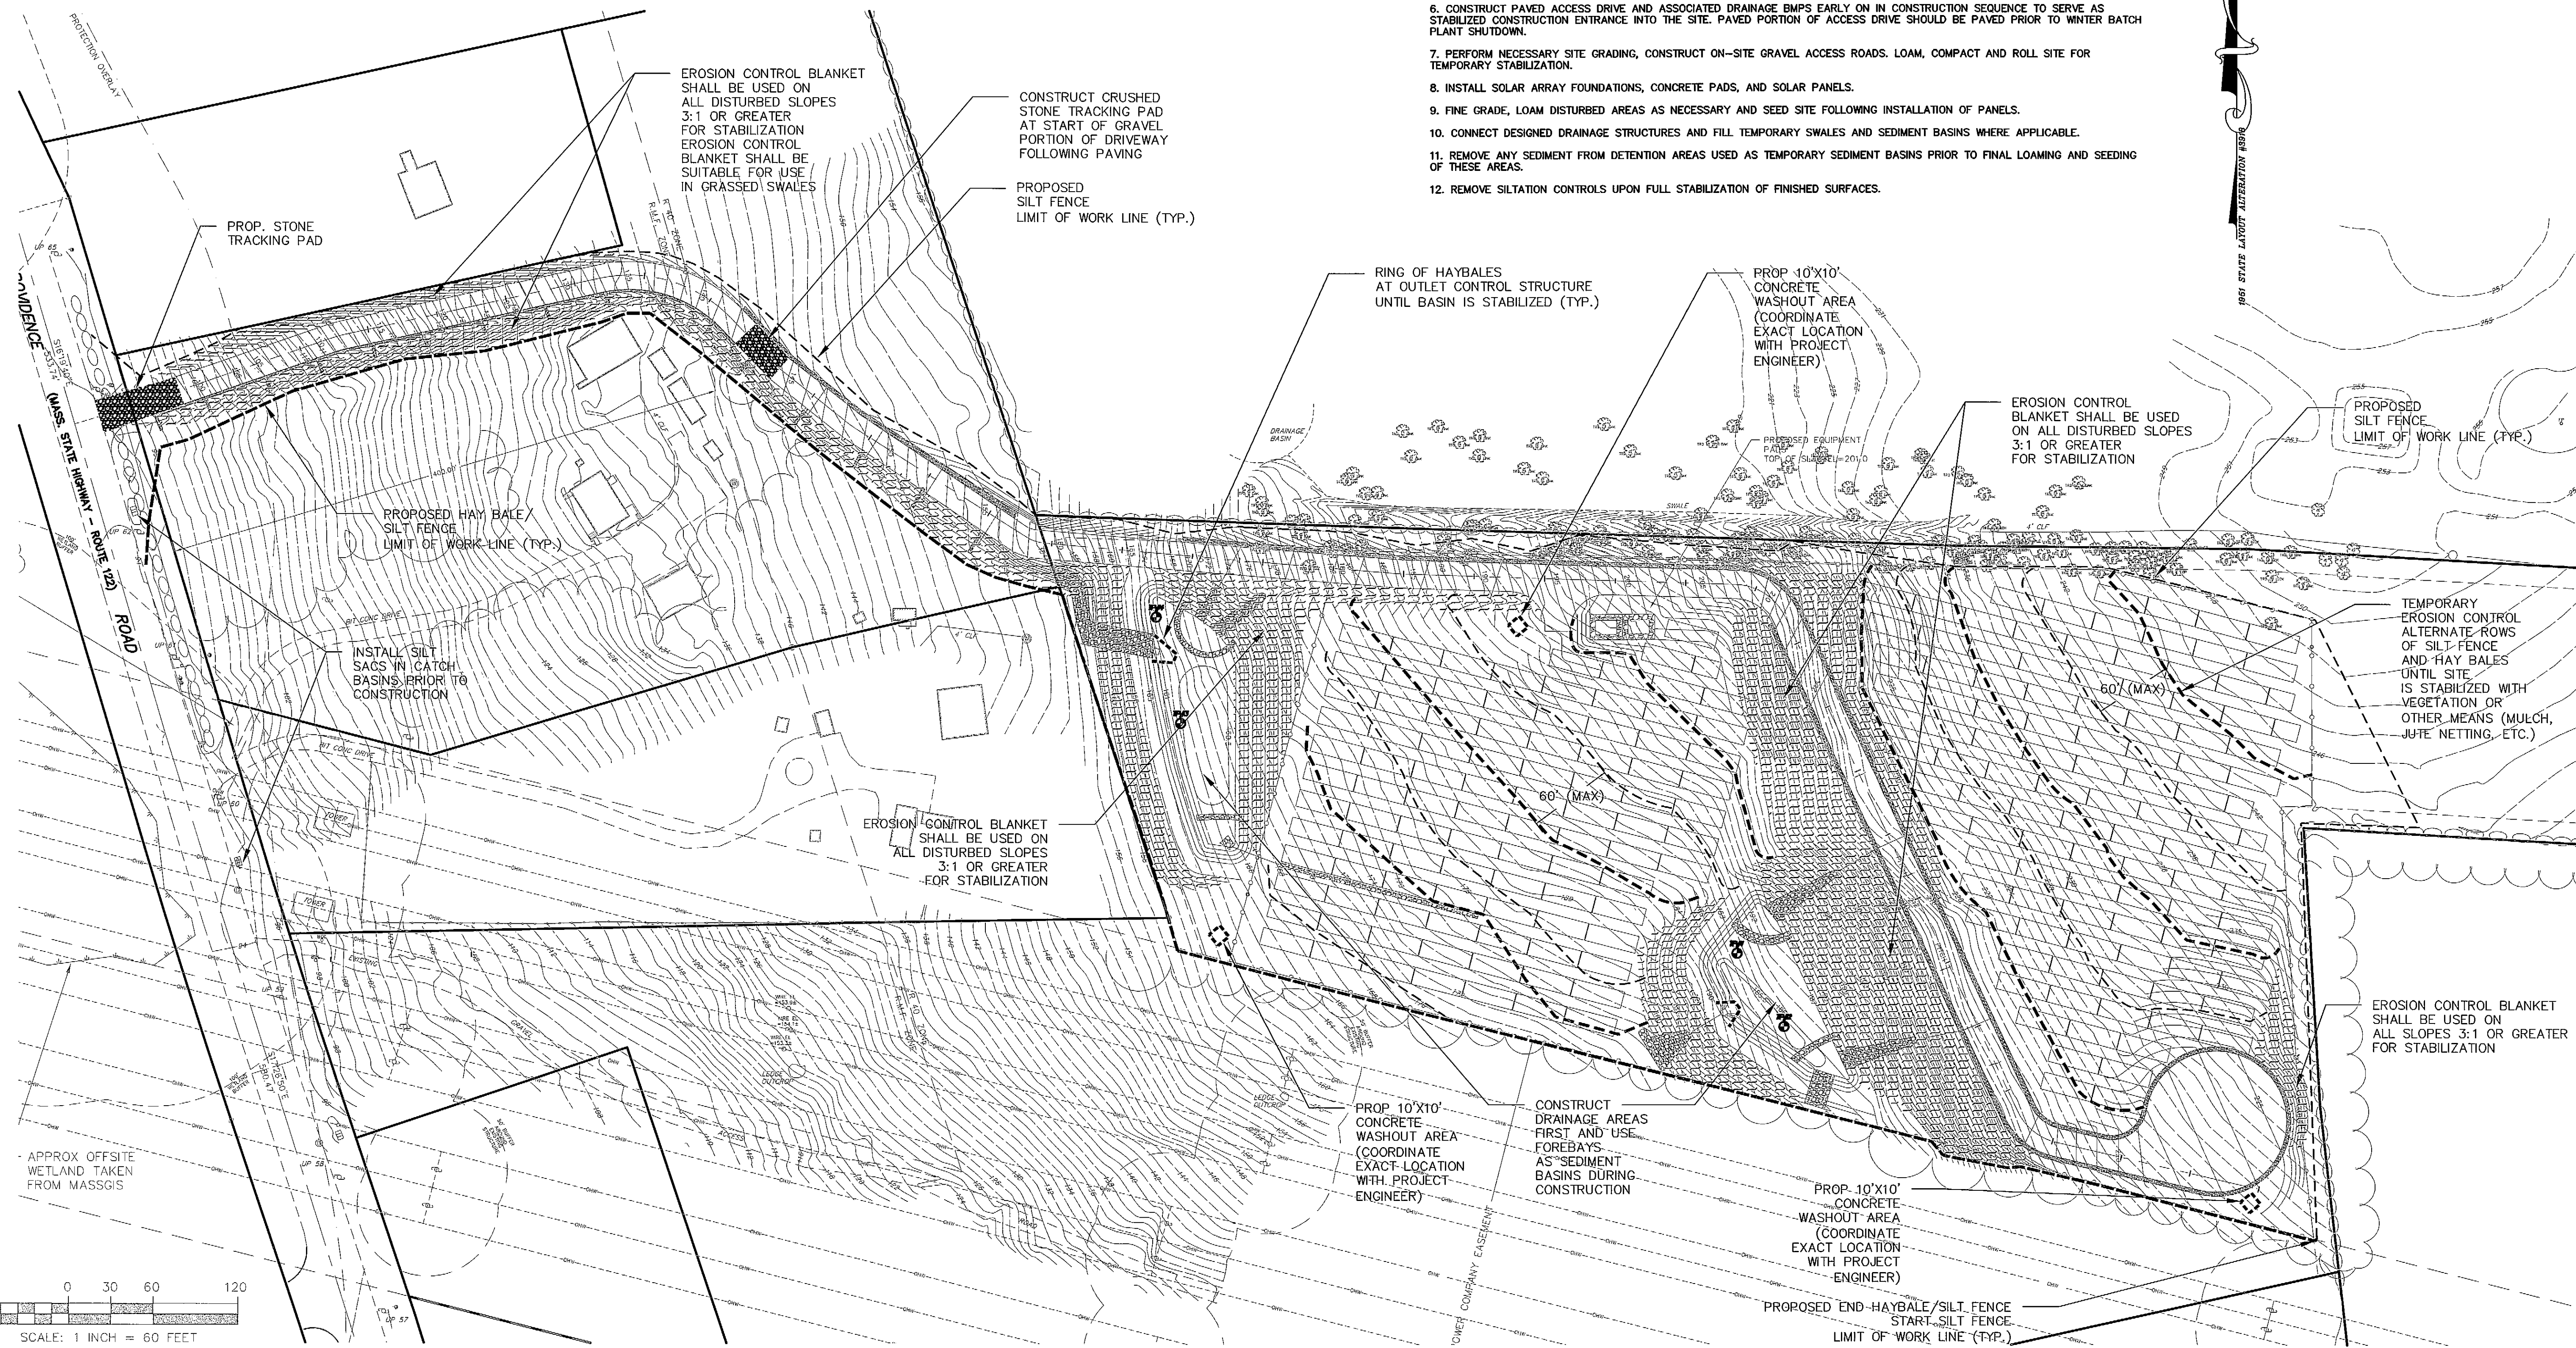

FIELD ENGINEERING CO., INC.
CONSULTING ENGINEERS

110 INDUSTRIAL DRIVE
P.O. BOX 1178
MATTAPANSETT, MA 02739
TEL: (508) 758-2749
FAX: (508) 758-2849

THE CROCKER BUILDING
4 COURT STREET SUITE 104
TAUNTON, MA 02780
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Revisions

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5	ADD SHEET 14 PER PB DECISION ISSUED FOR CONSTRUCTION	10/3/16	RRR
7	ISSUED FOR CONSTRUCTION	9/1/16	RRR
6	MINOR EDITS TO EROSION CONTROLS	8/10/16	RRR
5	REVISOR FOR NEW ACCESS ROAD	7/22/16	RRR
4	REVISOR FOR CON COM MEETING COMMENTS	12/9/15	RRR
3	REVISOR FOR CON COM AGENT COMMENTS	12/1/15	RRR
2	MINOR REVISIONS PER CONSULTANT REVIEW	10/22/15	RRR
1	REV PER PB COMMENT LETTERS	10/5/15	RRR

Date: 8/12/15

Scale: 1"=60'

Drawn By: RMS, Designed By: RRR, Checked By: RRR

Issued For: PERMITTING

Professional Seal: RICHARD R. RICCIO III, CIVIL ENGINEER, No. 45898, REGISTERED IN MASSACHUSETTS, 10/19/16



PROPOSED SITE DEVELOPMENT
CEC SOLAR #1056 LLC

207 PROVIDENCE ROAD
GRAFTON, MASSACHUSETTS

Drawing Title: EROSION CONTROL

Project No.: 2035, Sheet: 8 OF 14

EROS-1

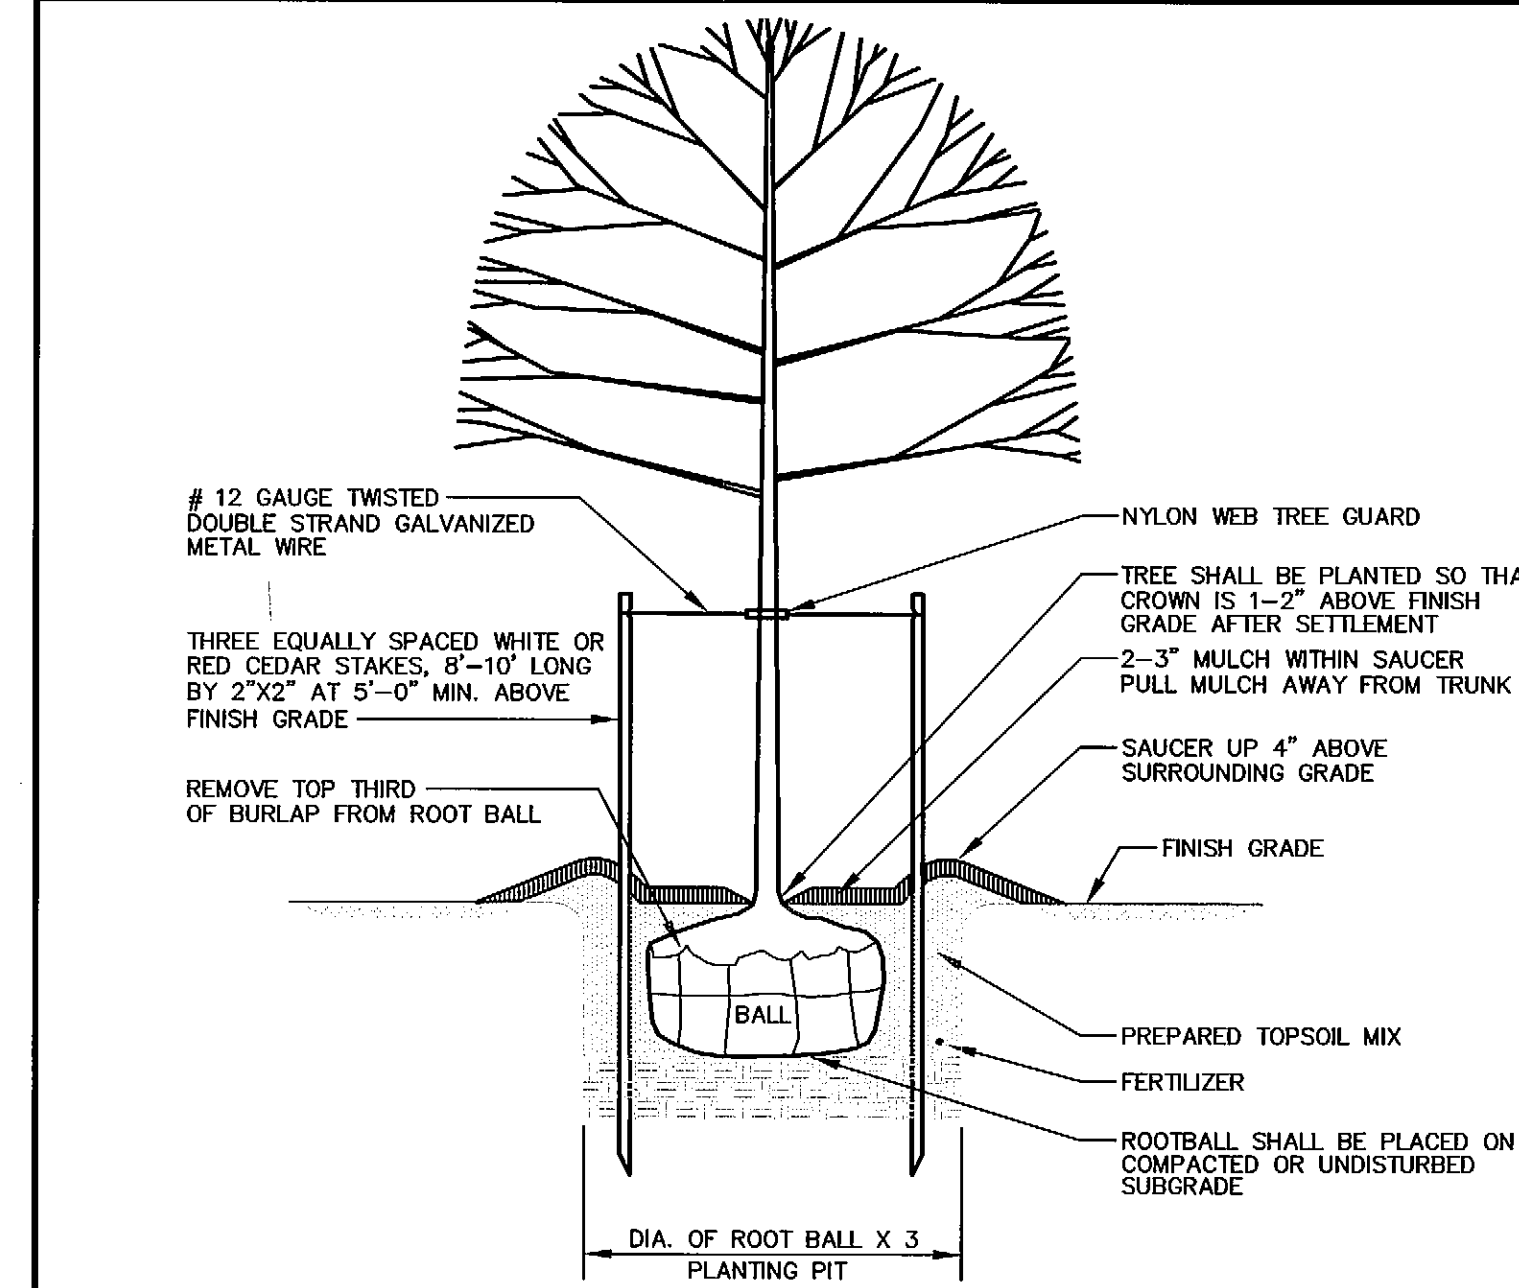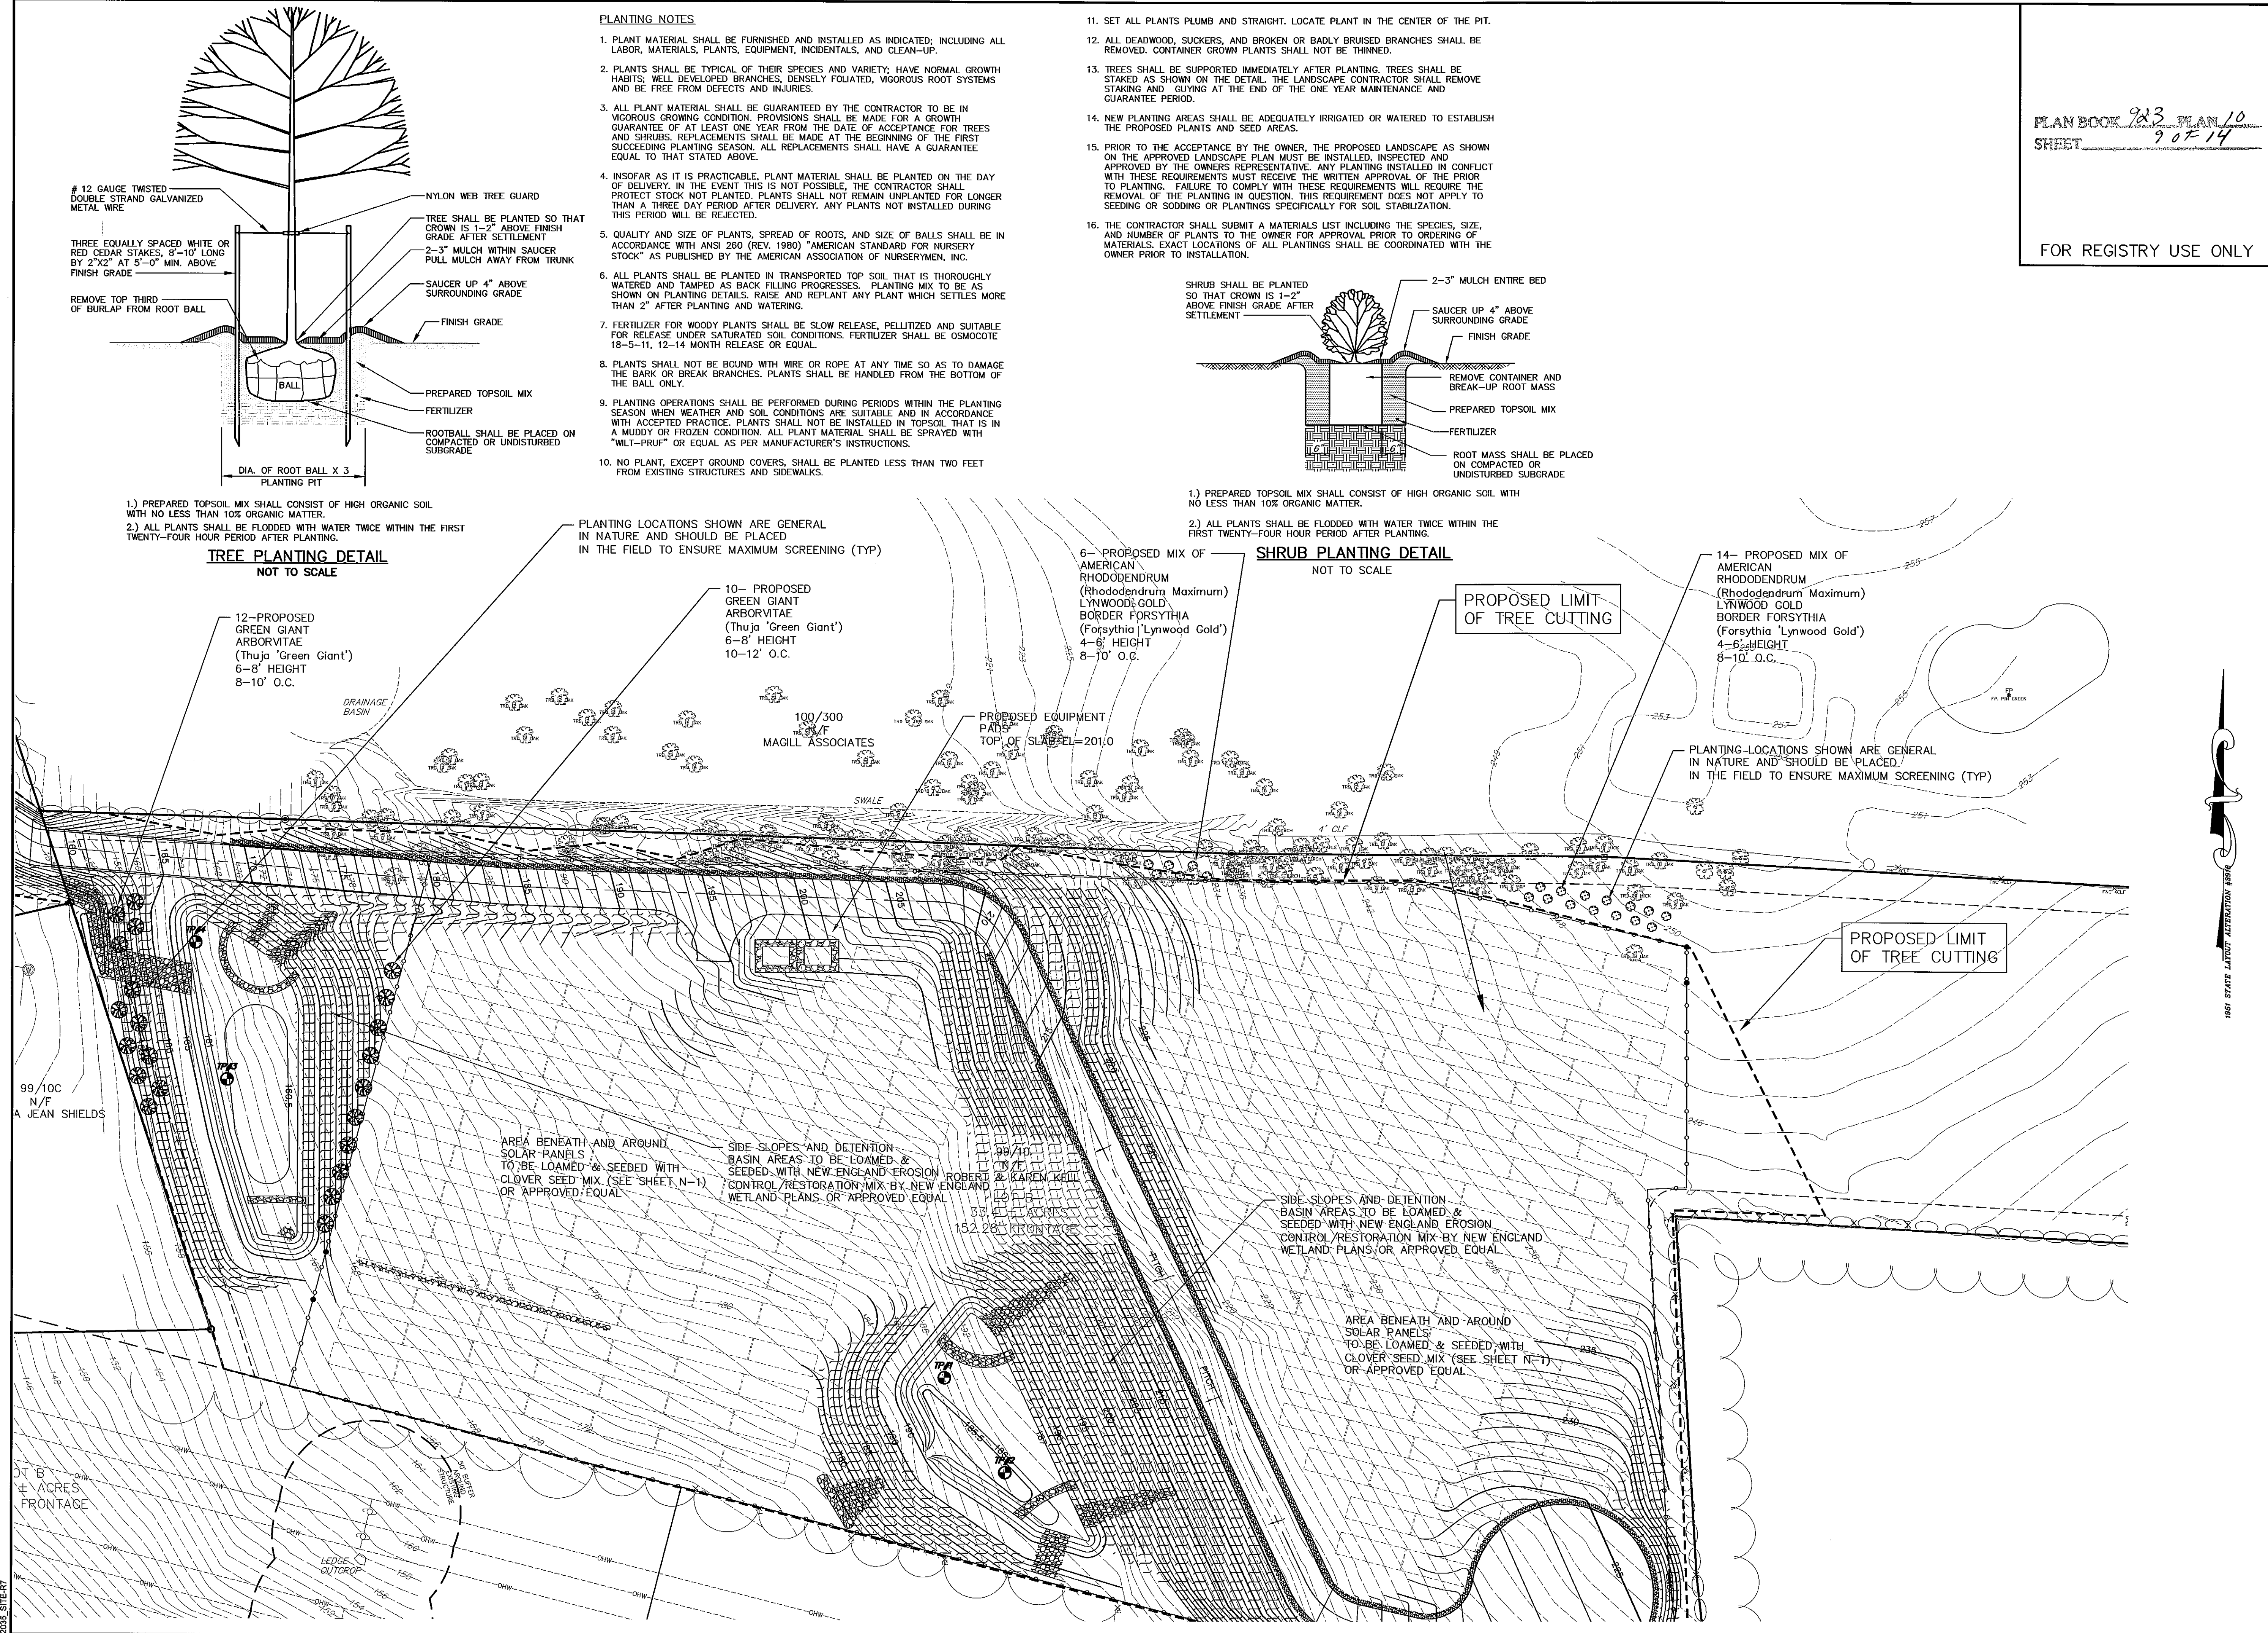

- 1.) PREPARED TOPSOIL MIX SHALL CONSIST OF HIGH ORGANIC SOIL WITH NO LESS THAN 10% ORGANIC MATTER.
- 2.) ALL PLANTS SHALL BE FLOODED WITH WATER TWICE WITHIN THE FIRST TWENTY-FOUR HOUR PERIOD AFTER PLANTING.

TREE PLANTING DETAIL
NOT TO SCALE

PLANTING LOCATIONS SHOWN ARE GENERAL IN NATURE AND SHOULD BE PLACED IN THE FIELD TO ENSURE MAXIMUM SCREENING (TYP)


12-PROPOSED GREEN GIANT ARBORVITAE (Thuja 'Green Giant') 6-8' HEIGHT 8-10' O.C.

10- PROPOSED GREEN GIANT ARBORVITAE (Thuja 'Green Giant') 6-8' HEIGHT 10-12' O.C.

6- PROPOSED MIX OF AMERICAN RHODODENDRUM (Rhododendrum Maximum) LYWOOD GOLD BORDER FORSYTHIA (Forsythia 'Lynwood Gold') 4-6' HEIGHT 8-10' O.C.

SHRUB PLANTING DETAIL
NOT TO SCALE

- 1.) PREPARED TOPSOIL MIX SHALL CONSIST OF HIGH ORGANIC SOIL WITH NO LESS THAN 10% ORGANIC MATTER.
- 2.) ALL PLANTS SHALL BE FLOODED WITH WATER TWICE WITHIN THE FIRST TWENTY-FOUR HOUR PERIOD AFTER PLANTING.

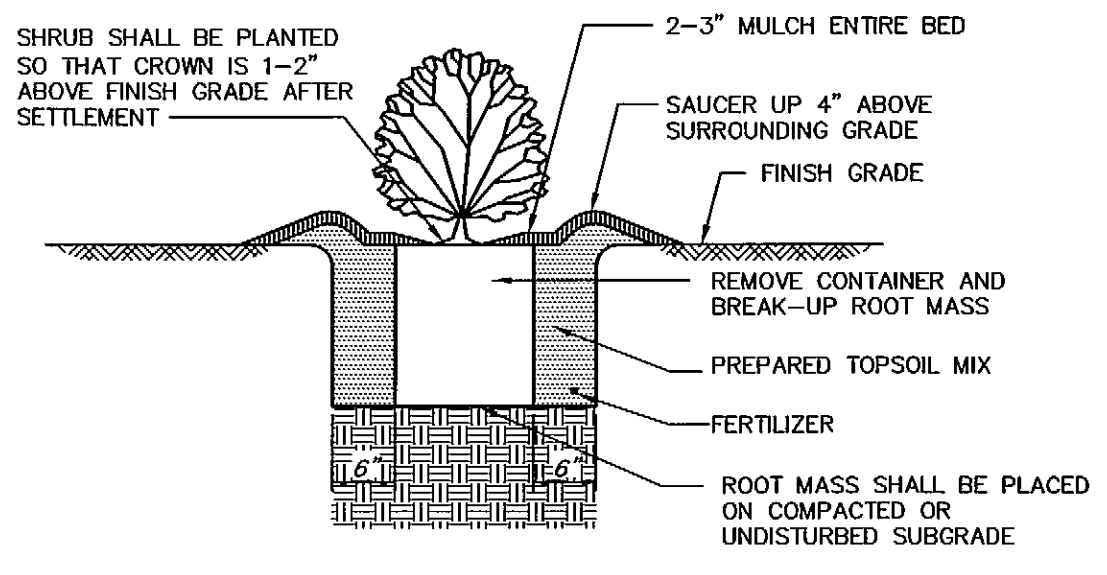

14- PROPOSED MIX OF AMERICAN RHODODENDRUM (Rhododendrum Maximum) LYWOOD GOLD BORDER FORSYTHIA (Forsythia 'Lynwood Gold') 4-6' HEIGHT 8-10' O.C.

PLANTING LOCATIONS SHOWN ARE GENERAL IN NATURE AND SHOULD BE PLACED IN THE FIELD TO ENSURE MAXIMUM SCREENING (TYP)

PROPOSED LIMIT OF TREE CUTTING


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CONSULTING ENGINEERS

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MATTAPAN, MA 02726
TEL: (508) 758-2749
FAX: (508) 758-2849

THE CROCKER BUILDING
4 COURT STREET, SUITE 104
TAUNTON, MA 02720
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PLAN BOOK 923 PLAN 10
SHEET 9 OF 14

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Revisions				
5	ADD SHEET 14 PER PB DECISION	10/3/16	RRR	
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1	REV PER PB COMMENT LETTERS	10/15/15	RRR	
No.	Description	Date	Appvd.	
Date 8/12/15				
Scale 1"=40'				
Drawn By RMS		Designed By RRR		Checked By RRR
Issued For PERMITTING				
				

PROPOSED SITE DEVELOPMENT
CEC SOLAR #1056 LLC

207 PROVIDENCE ROAD
GRAFTON, MASSACHUSETTS


Drawing Title
LANDSCAPE PLAN

Project No. 2035 Sheet 9 OF 14

LAND-1



SITE PLAN
SCALE: 1"=20'

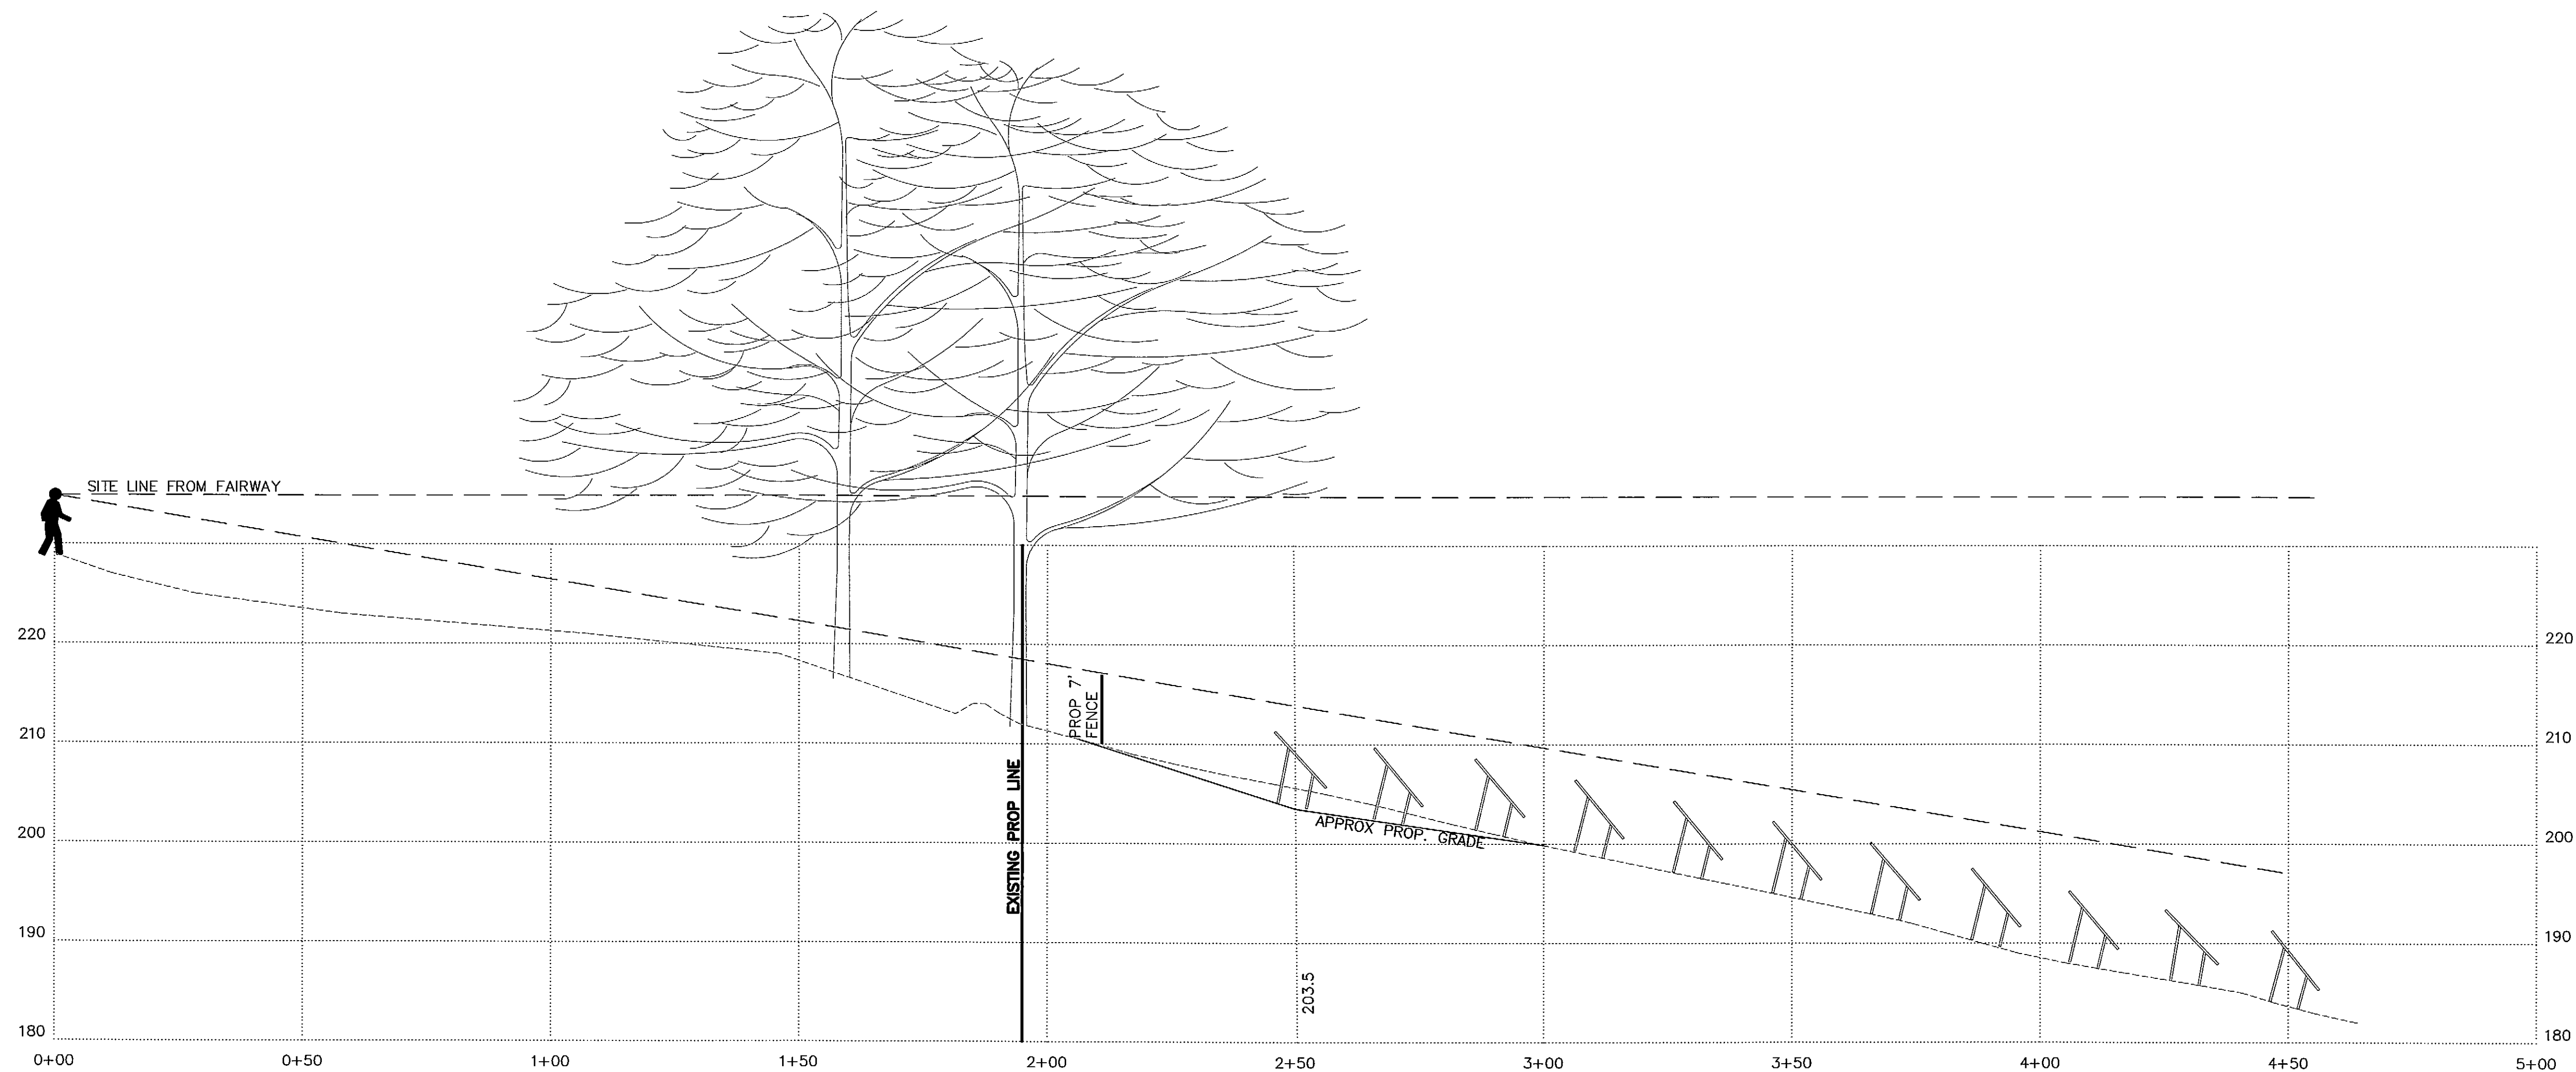

PROFILE A
SCALE: 1"=20' HORIZ.
1"=10' VERT.

PLAN BOOK 923 PLAN 10
SHEET 10 OF 14

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1	REV PER PB COMMENT LETTERS	10/5/15	RRR
No	Description	Date	Apprv


Date 8/12/15

Scale AS NOTED

Drawn By RMS	Designed By RRR	Checked By RRR
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Issued For

PERMITTING

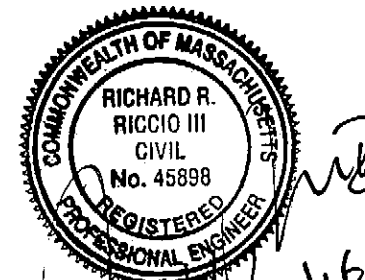

PROPOSED SITE DEVELOPMENT

CEC SOLAR #1056 LLC

207 PROVIDENCE ROAD
GRAFTON, MASSACHUSETTS

Drawing Title
VIEW STUDY FROM
ADJACENT FAIRWAY

Project No. 2035	Sheet 10 OF 14
---------------------	-------------------

VS-1



SITE PLAN
SCALE: 1"=20'



PLAN BOOK 923 PLAN 10
SHEET 11 OF 14

FOR REGISTRY USE ONLY

**FIELD
ENGINEERING
CO., INC.**
CONSULTING ENGINEERS

11D INDUSTRIAL DRIVE
P.O. BOX 1178
MATTAPOISETT, MA 02739
TEL: (508) 758-2749
FAX: (508) 758-2849

THE CROCKER BUILDING
4 COURT STREET SUITE 104
TAUNTON, MA 02780
TEL: (508) 824-9279
FAX: (508) 824-9276

Revisions					
5	ADD SHEET 14		10/3/16	RRR	
4	PER PB DECISION				
3	ISSUED FOR		9/1/16	RRR	
3	CONSTRUCTION		7/22/16	RRR	
	REVISED FOR NEW				
	ACCESS ROAD				
2	MINOR REVISIONS PER		10/22/15	RRR	
	CONSULTANT REVIEW				
1	REV PER PB		10/6/15	RRR	
1	COMMENT LETTERS				
No.	Description	Date		Appvd.	

Date 8/12/15

Scale	AS NOTED
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Drawn By RMS	Designed By RRR	Checked By RRR
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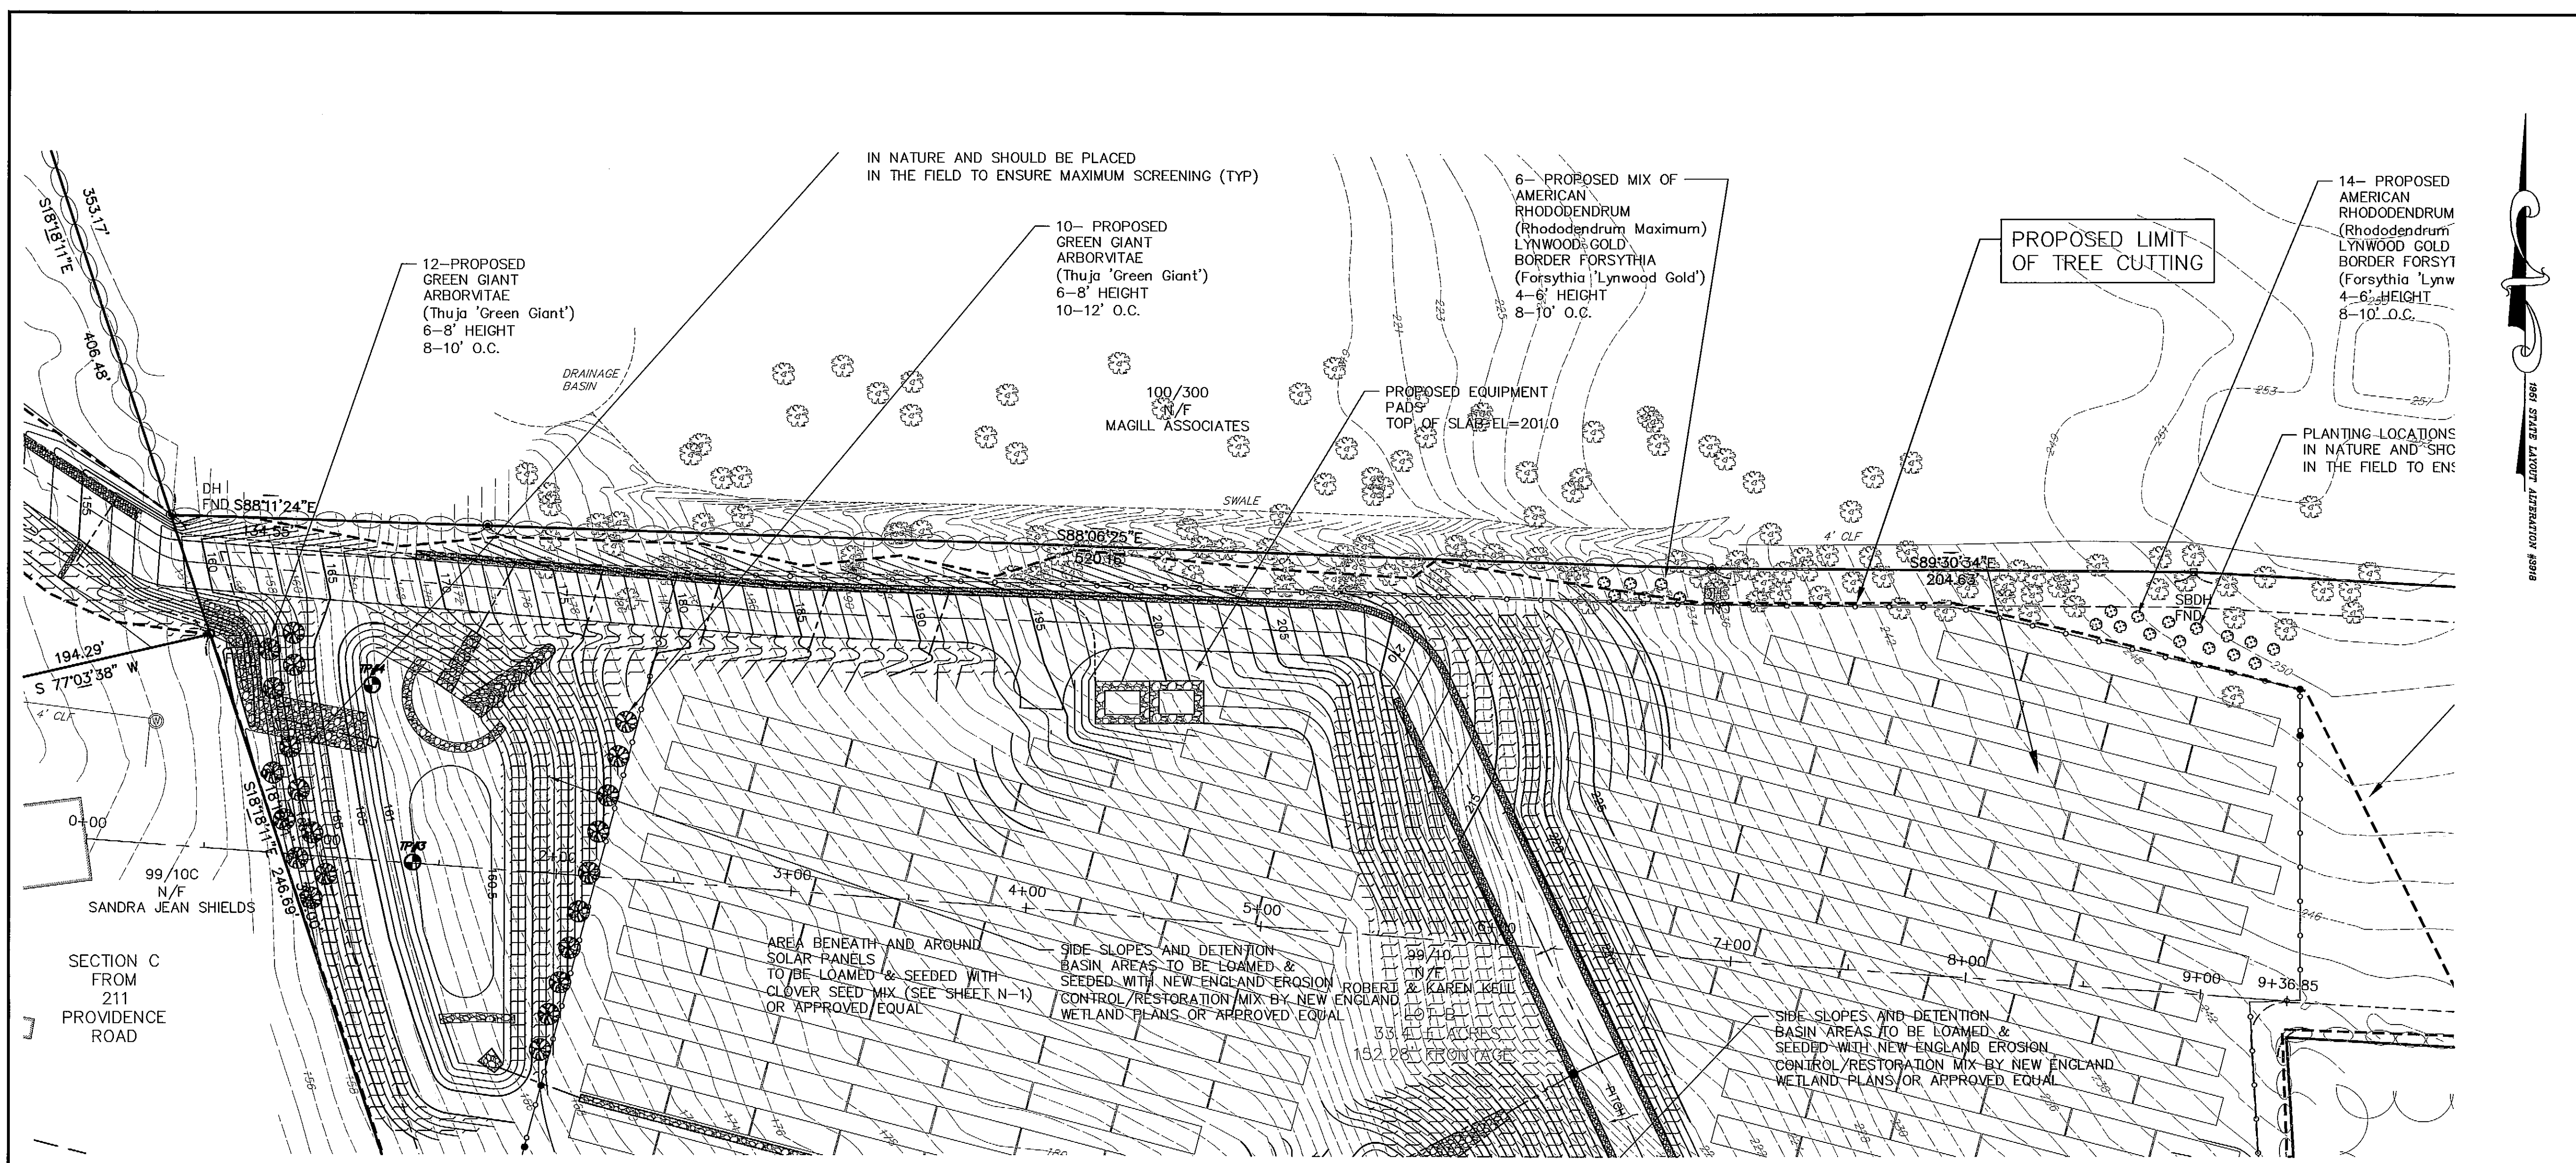
PROPOSED SITE DEVELOPMENT
CEC SOLAR #1056 LLC

207 PROVIDENCE ROAD
GRAFTON, MASSACHUSETTS


VIEW STUDY FROM
SILVER SPRUCE DR

Project No. 2035	Sheet 11 OF 14
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VS-2



SITE PLAN
SCALE: 1"=40'

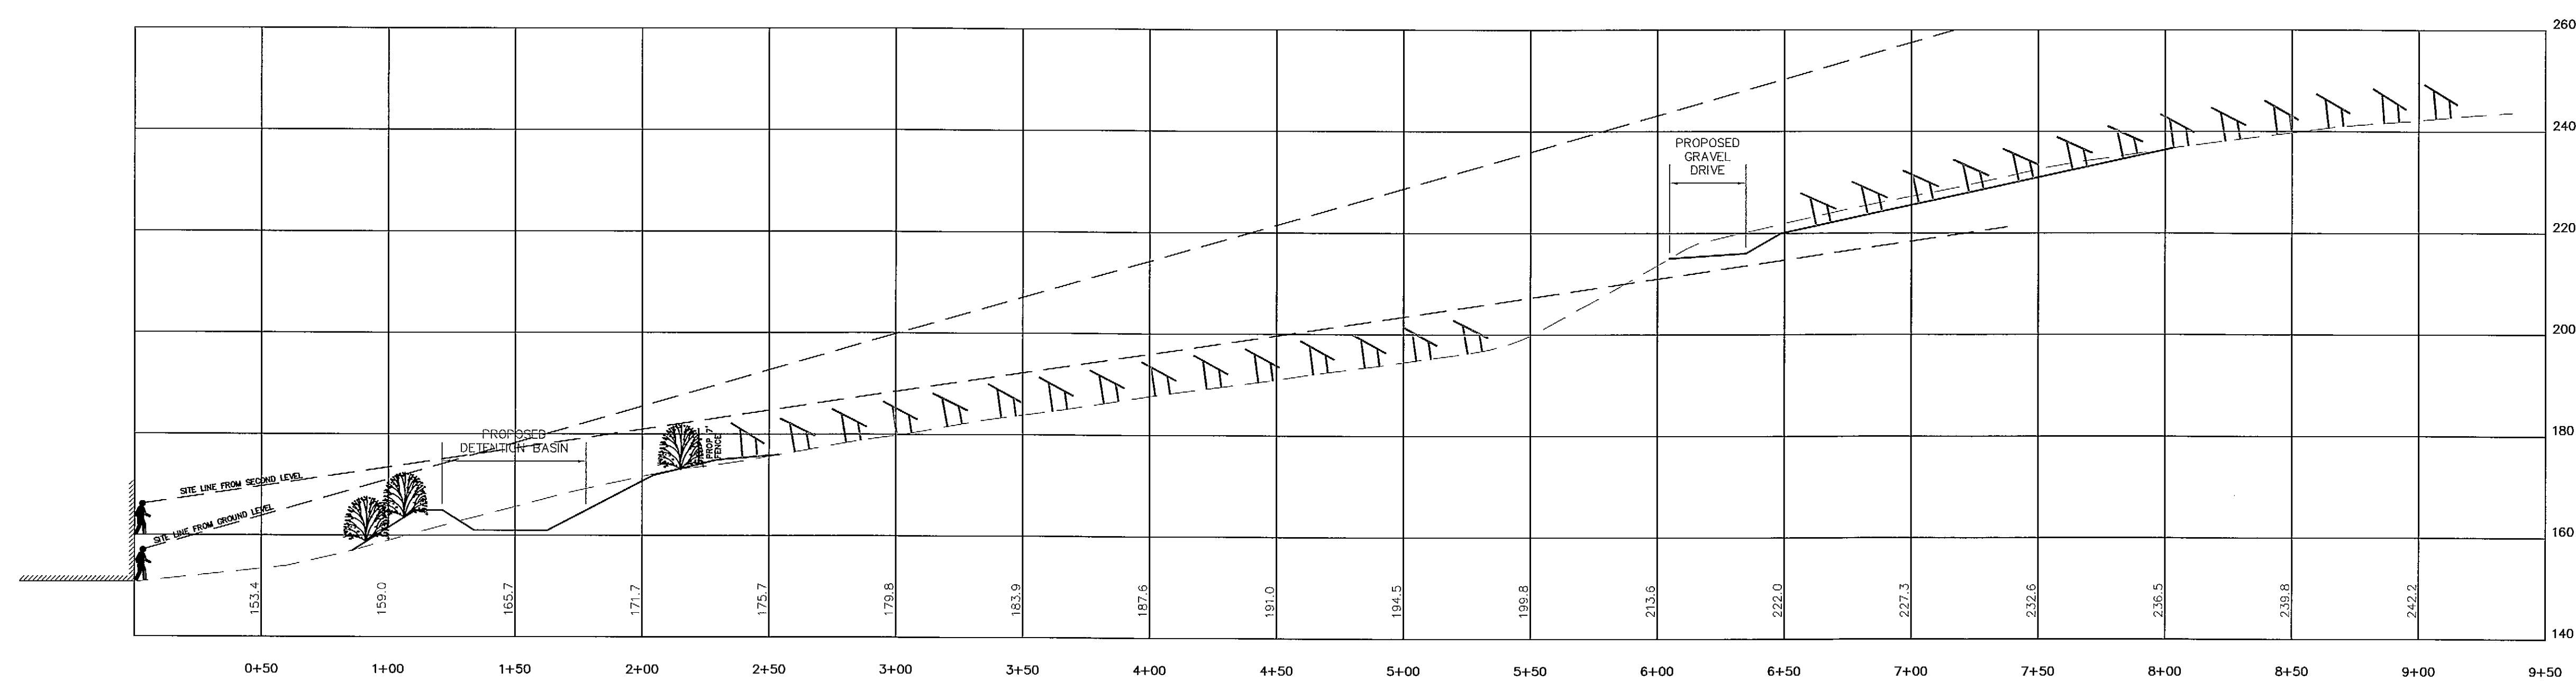

PROFILE C
SCALE: 1"=40' HORIZ.
1"=20' VERT.

PLAN BOOK 923 PLAN 10
SHEET 12 OF 14

FOR REGISTRY USE ONLY

FIELD ENGINEERING CO., INC.
CONSULTING ENGINEERS

110 INDUSTRIAL DRIVE
P.O. BOX 1178
MATTAPAN, MA 02739
TEL: (508) 758-2749
FAX: (508) 758-2849

THE CROCKER BUILDING
4 COURT STREET, SUITE 104
TAUNTON, MA 02780
TEL: (508) 824-9279
FAX: (508) 824-9276

Revisions

No.	Description	Date	App'd
5	ADD SHEET 14 PER PB DECISION	10/3/16	RRR
4	ISSUED FOR CONSTRUCTION	9/1/16	RRR
3	REVISED FOR NEW ACCESS ROAD	7/22/15	RRR
2	MINOR REVISIONS PER CONSULTANT REVIEW	10/22/15	RRR
1	REV PER PB COMMENT LETTERS	10/15/15	RRR

Date 8/12/15

Scale AS NOTED

Drawn By	Designed By	Checked By
RMS	RRR	RRR

Issued For

PERMITTING

Professional Engineer Seal: RICHARD P. RICO III, CIVIL, No. 45898, REGISTERED PROFESSIONAL ENGINEER, 10/19/16

PROPOSED SITE DEVELOPMENT
CEC SOLAR #1056 LLC

207 PROVIDENCE ROAD
GRAFTON, MASSACHUSETTS

Drawing Title
VIEW STUDY FROM 211 PROVIDENCE RD

Project No.	Sheet
2035	12 OF 14

VS-3

[illegible]